

February 2023

London Luton Airport Expansion

Planning Inspectorate Scheme Ref: TR020001

Volume 4 Plans and Sections
4.09 General Arrangement Drawings (Part 1 of 3)

Application Document Ref: TR020001/APP/4.09 APFP Regulation 5(2)(o)



The Planning Act 2008

The Infrastructure Planning (Applications: Prescribed Forms and Procedure) Regulations 2009

London Luton Airport Expansion Development Consent Order 202x

4.09 GENERAL ARRANGEMENT DRAWINGS (PART 1 OF 3)

Regulation number:	Regulation 5(2)(o)
Planning Inspectorate Scheme Reference:	TR020001
Document Reference:	TR020001/APP/4.09
Author:	Luton Rising

Version	Date	Status of Version
Issue 1	February 2023	Application issue

London Luton Airport Expansion Development Consent Order

General Arrangement Drawings

Contents

		Page
I	General Arrangement Drawings	1
1.1	Purpose of this document	1
1.2	Scope and format of the General Arrangements Drawings	1
1.3	General Arrangement Drawings list	1

London Luton Airport Expansion Development Consent Order

1 GENERAL ARRANGEMENT DRAWINGS

1.1 Purpose of this document

1.1.1 Luton Rising (a trading name of London Luton Airport Limited), owners of London Luton Airport (the Applicant) has submitted an application under section 37 of the Planning Act 2008 for an order to grant development consent for the expansion of London Luton Airport (the Proposed Development).

- 1.1.2 This document is part of a suite of documents which forms part of the application for development consent. A full description of all the Application Documents is provided in the Introduction to the Application [TR020001/APP/1.03] which also forms part of the suite of application documents.
- 1.1.3 This document is included in the application to comply with Regulation 5(2)(o) of the Infrastructure Planning (Applications: Prescribed Forms and Procedures) Regulations 2009 ("the 2009 Regulations"), which requires:
 - i. 5(2)(o) 'any other plans, drawings and sections necessary to describe the proposals for which development consent is sought, showing details of design, external appearance, and the preferred layout of buildings or structures, drainage, surface water management, means of vehicular and pedestrian access, any car parking to be provided, and means of landscaping'
- 1.1.4 As this document is part of the application documentation, it should be read alongside, and is informed by, the other application documents. In particular, the plans should be read alongside Schedule 1 of the draft Order [TR020001/APP/2.01] and the Work Plans [TR020001/APP/4.04].

1.2 Scope and format of the General Arrangements Drawings

- 1.2.1 The purpose of the General Arrangement Drawings is to illustrate what certain parts of the Proposed Development might look like. This includes showing indicative floorplans and elevations of terminal and ancillary buildings as well as structures such as the surface movement radar.
- The information shown on these drawings is in line with the preliminary design status of the project and is therefore indicative. Parameters for the various works are provided for in the **draft**Order [TR020001/APP/2.01] and any detailed design will be in accordance with those parameters and the other constraints imposed by the draft Order.
- 1.2.3 Drawings showing road junction mitigation works that will be necessary as a result of the Proposed Development are shown in the **Transport Assessment [TR020001/APP/7.02]** alongside an explanation of why these are needed and what they entail. Those drawings are included in the Transport Assessment, rather than in this document, because they contain information which is necessary to inform the approach to the Transport Assessment.

1.3 General Arrangement Drawings list

Drawing Name	Drawing Number	Work No.	Document Part
Assessment Phase 1 Earthworks Proposed Indicative Landform	LLADCO-3C-ARP-WHS-BEW-DR-GT-0401	1a	Part 1 of 3
Assessment Phase 2a Earthworks Proposed Indicative Landform	LLADCO-3C-ARP-WHS-BEW-DR-GT-0403	1a	Part 1 of 3
Assessment Phase 2b Earthworks Proposed Indicative Landform	LLADCO-3C-ARP-WHS-BEW-DR-GT-0405	1a	Part 1 of 3
Indicative Surface Movement Radar Plan & Section	LLADCO-3C-ACM-AIR-MSC-DR-CE-0001	2a(02)	Part 1 of 3
Indicative Fire Training Ground Plan & Section	LLADCO-3C-ACM-AIR-FTR-DR-CE-0001	2d	Part 1 of 3
Indicative Engine Run-Up Bay Plan & Section	LLADCO-3C-ACM-AIR-ENG-DR-CE-0001	2f,2g	Part 1 of 3
Indicative General Arrangement Terminal 1 New Pier C & External Canopy - Plan & Section	LLADCO-3C-IDM-STR-TR1-DR-AR-0001	3a	Part 1 of 3
Indicative General Arrangement Terminal 1 South Extension	LLADCO-3C-IDM-STR-TR1-DR-AR-0004	3a(03)	Part 1 of 3
Indicative General Arrangement Terminal 1 North Extensions	LLADCO-3C-IDM-STR-TR1-DR-AR-0007	3a(02) / 3a(04)	Part 1 of 3
Indicative General Arrangement Terminal 1 Baggage Hall Extensions Plan & Section	LLADCO-3C-IDM-STR-TR1-DR-AR-0008	3a(05)	Part 1 of 3
Indicative Terminal 2 General Arrangement Overall Zone Use Level 00 Assessment Phase 2a	LLADCO-3C-ACM-AIR-TER-DR-AR-0103	3b(01)	Part 1 of 3
Indicative Terminal 2 General Arrangement Overall Zone Use Level 00 Assessment Phase 2b	LLADCO-3C-ACM-AIR-TER-DR-AR-0104	3b(02)	Part 1 of 3


London Luton Airport Expansion Development Consent Order


Drawing Name	Drawing Number	Work No.	Document Part
Indicative Terminal 2 General Arrangement Overall Zone Use Level 01 Assessment Phase 2a	LLADCO-3C-ACM-AIR-TER-DR-AR-0105	3b(01)	Part 1 of 3
Indicative Terminal 2 General Arrangement Overall Zone Use Level 01 Assessment Phase 2b	LLADCO-3C-ACM-AIR-TER-DR-AR-0106	3b(02)	Part 1 of 3
Indicative Terminal 2 General Arrangement Main Building Zone Use Level 00 Assessment Phase 2a	LLADCO-3C-ACM-AIR-TER-DR-AR-0107	3b(01)	Part 1 of 3
Indicative Terminal 2 General Arrangement Main Building Zone Use Level 00 Assessment Phase 2b	LLADCO-3C-ACM-AIR-TER-DR-AR-0108	3b(02)	Part 1 of 3
Indicative Terminal 2 General Arrangement Main Building Zone Use Level 01 Assessment Phase 2a	LLADCO-3C-ACM-AIR-TER-DR-AR-0109	3b(01	Part 1 of 3
Indicative Terminal 2 General Arrangement Main Building Zone Use Level 01 Assessment Phase 2b	LLADCO-3C-ACM-AIR-TER-DR-AR-0110	3b(02)	Part 1 of 3
Indicative Terminal 2 Cross Sections Assessment Phase 2b	LLADCO-3C-ACM-AIR-TER-DR-AR-0401	3b(01)	Part 1 of 3
Indicative Terminal 2 Pier Cross Sections Assessment Phase 2b	LLADCO-3C-ACM-AIR-TER-DR-AR-0402	3b(02)	Part 1 of 3
Indicative Terminal 2 General Arrangement Floor Plan West Pier Level 00 Assessment Phase 2b	LLADCO-3C-ACM-AIR-WP2-DR-AR-0111	3c(01)	Part 1 of 3
Indicative Terminal 2 General Arrangement Floor Plan West Pier Level 01 Assessment Phase 2b	LLADCO-3C-ACM-AIR-WP2-DR-AR-0112	3c(01)	Part 1 of 3
Indicative Terminal 2 General Arrangement Floor Plan East Pier Level 00 Assessment Phase 2b	LLADCO-3C-ACM-AIR-EP2-DR-AR-0113	3c(02)	Part 1 of 3
Indicative Terminal 2 General Arrangement Floor Plan East Pier Level 01 Assessment Phase 2b	LLADCO-3C-ACM-AIR-EP2-DR-AR-0114	3c(02)	Part 1 of 3
Indicative Coach Station Sections & Elevations	LLADCO-3C-CAP-STR-SFA-PRK-AR-1383	3d	Part 1 of 3
Indicative Luton Dart Extension- Plan and Section	LLADCO-3C-ARP-RAL-MPT-DR-AR-6002	3g	Part 1 of 3
Indicative Energy Centre & Terminal 2 Service Yard Welfare Unit Sections & Elevations	LLADCO-3C-CAP-STR-WRH-WRH-AR-1312	3h	Part 1 of 3
Indicative Airport Operations and Maintenance Elevations	LLADCO-3C-CAP-STR-WRH-AR-1354	3i	Part 1 of 3
Indicative Hotel Elevations	LLADCO-3C-CAP-STR-HTL-DR-AR-1273	4a	Part 2 of 3
Indicative Hangar A & B Elevations	LLADCO-3C-CAP-STR-WRH-WRH-AR-1373	4b	Part 2 of 3
Indicative Layout for Fuel Storage Facility	LLADCO-3C-ACM-AIR-FFA-DR-CE-0002	4c	Part 2 of 3
Indicative General Arrangement Above Ground Fuel Installation	LLADCO-3C-ACM-AIR-FFA-DR-CE-0005	4c	Part 2 of 3
Indicative Solar Battery Storage Elevations	LLADCO-3C-CAP-STR-WRH-DR-AR-1393	4e	Part 2 of 3
Indicative Airside-Landside Boundary Sections	LLADCO-3C-ACM-AIR-FEN-DR-CE-0005	4f	Part 2 of 3
Indicative General Arrangement Airfield Fencing Assessment Phase 1	LLADCO-3C-ACM-AIR-FEN-DR-CE-0006	4f	Part 2 of 3
Indicative General Arrangement Airfield Fencing Assessment Phase 2a	LLADCO-3C-ACM-AIR-FEN-DR-CE-0002	4f	Part 2 of 3
Indicative Airfield Fencing Layout Assessment Phase 2b	LLADCO-3C-ACM-AIR-FEN-DR-CE-0001	4f	Part 2 of 3
Indicative Deck & Surface Carpark Elevations	LLADCO-3C-CAP-STR-PRK-DR-AR-1413	4k(01)	Part 2 of 3
Indicative Deck & Surface Parking Elevations	LLADCO-3C-CAP-STR-PRK-DR-AR-1313	40(01) / 40(02)	Part 2 of 3
Indicative General Arrangement Solar Car Port	LLADCO-3C-ACM-INF-MSC-DR-AR-0001	4p(02) / 4q(02)	Part 2 of 3
Indicative Forecourt Multistorey Car Park Typical Plan	LLADCO-3C-CAP-STR-PRK-DR-AR-1208	4r	Part 2 of 3
Indicative Multistorey Car Park Elevations	LLADCO-3C-CAP-STR-PRK-DR-AR-1210	4r	Part 2 of 3
Indicative Police Station Elevations	LLADCO-3C-CAP-STR-OFC-OFC-AR-1342	4u	Part 2 of 3
Indicative Substation Layout & Elevations	LLADCO-3C-ACM-AIR-UTL-DR-CE-0020	4w / 4x	Part 2 of 3


London Luton Airport Expansion Development Consent Order


Drawing Name	Drawing Number	Work No.	Document Part
Airport Access Road Indicative Highways General Arrangement Key plan	LLADCO-3C-ARP-WHS-HWM-DR-HY-0100	6a(01), 6a(02), 6a(03)	Part 3 of 3
Airport Access Road Indicative Highways General Arrangement Sheet 1 of 10	LLADCO-3C-ARP-SFA-HWM-DR-HY-0101	6a(01), 6a(02), 6a(03)	Part 3 of 3
Airport Access Road Indicative Highways General Arrangement Sheet 2 of 10	LLADCO-3C-ARP-SFA-HWM-DR-HY-0102	6a(01), 6a(02), 6a(03)	Part 3 of 3
Airport Access Road Indicative Highways General Arrangement Sheet 3 of 10	LLADCO-3C-ARP-SFA-HWM-DR-HY-0103	6a(01), 6a(02), 6a(03)	Part 3 of 3
Airport Access Road Indicative Highways General Arrangement Sheet 4 of 10	LLADCO-3C-ARP-SFA-HWM-DR-HY-0104	6a(01), 6a(02), 6a(03)	Part 3 of 3
Airport Access Road Indicative Highways General Arrangement Sheet 5 of 10	LLADCO-3C-ARP-SFA-HWM-DR-HY-0105	6a(01), 6a(02), 6a(03)	Part 3 of 3
Airport Access Road Indicative Highways General Arrangement Sheet 6 of 10	LLADCO-3C-ARP-SFA-HWM-DR-HY-0106	6a(01), 6a(02), 6a(03)	Part 3 of 3
Airport Access Road Indicative Highways General Arrangement Sheet 7 of 10	LLADCO-3C-ARP-SFA-HWM-DR-HY-0107	6a(01), 6a(02), 6a(03)	Part 3 of 3
Airport Access Road Indicative Highways General Arrangement Sheet 8 of 10	LLADCO-3C-ARP-SFA-HWM-DR-HY-0108	6a(01), 6a(02), 6a(03)	Part 3 of 3
Airport Access Road Indicative Highways General Arrangement Sheet 9 of 10	LLADCO-3C-ARP-SFA-HWM-DR-HY-0109	6a(01), 6a(02), 6a(03)	Part 3 of 3
Airport Access Road Indicative Highways General Arrangement Sheet 10 of 10	LLADCO-3C-ARP-SFA-HWM-DR-HY-0110	6a(01), 6a(02), 6a(03)	Part 3 of 3
Airport Access Road Indicative Highways Cross Sections Sheet 1 of 4	LLADCO-3C-ARP-SFA-HWM-DR-HY-0501	6a(01), 6a(02), 6a(03)	Part 3 of 3
Airport Access Road Indicative Highways Cross Sections Sheet 2 of 4	LLADCO-3C-ARP-SFA-HWM-DR-HY-0502	6a(01), 6a(02), 6a(03)	Part 3 of 3
Airport Access Road Indicative Highways Cross Sections Sheet 3 of 4	LLADCO-3C-ARP-SFA-HWM-DR-HY-0503	6a(01), 6a(02), 6a(03)	Part 3 of 3
Airport Access Road Indicative Highways Cross Sections Sheet 4 of 4	LLADCO-3C-ARP-SFA-HWM-DR-HY-0504	6a(01), 6a(02), 6a(03)	Part 3 of 3



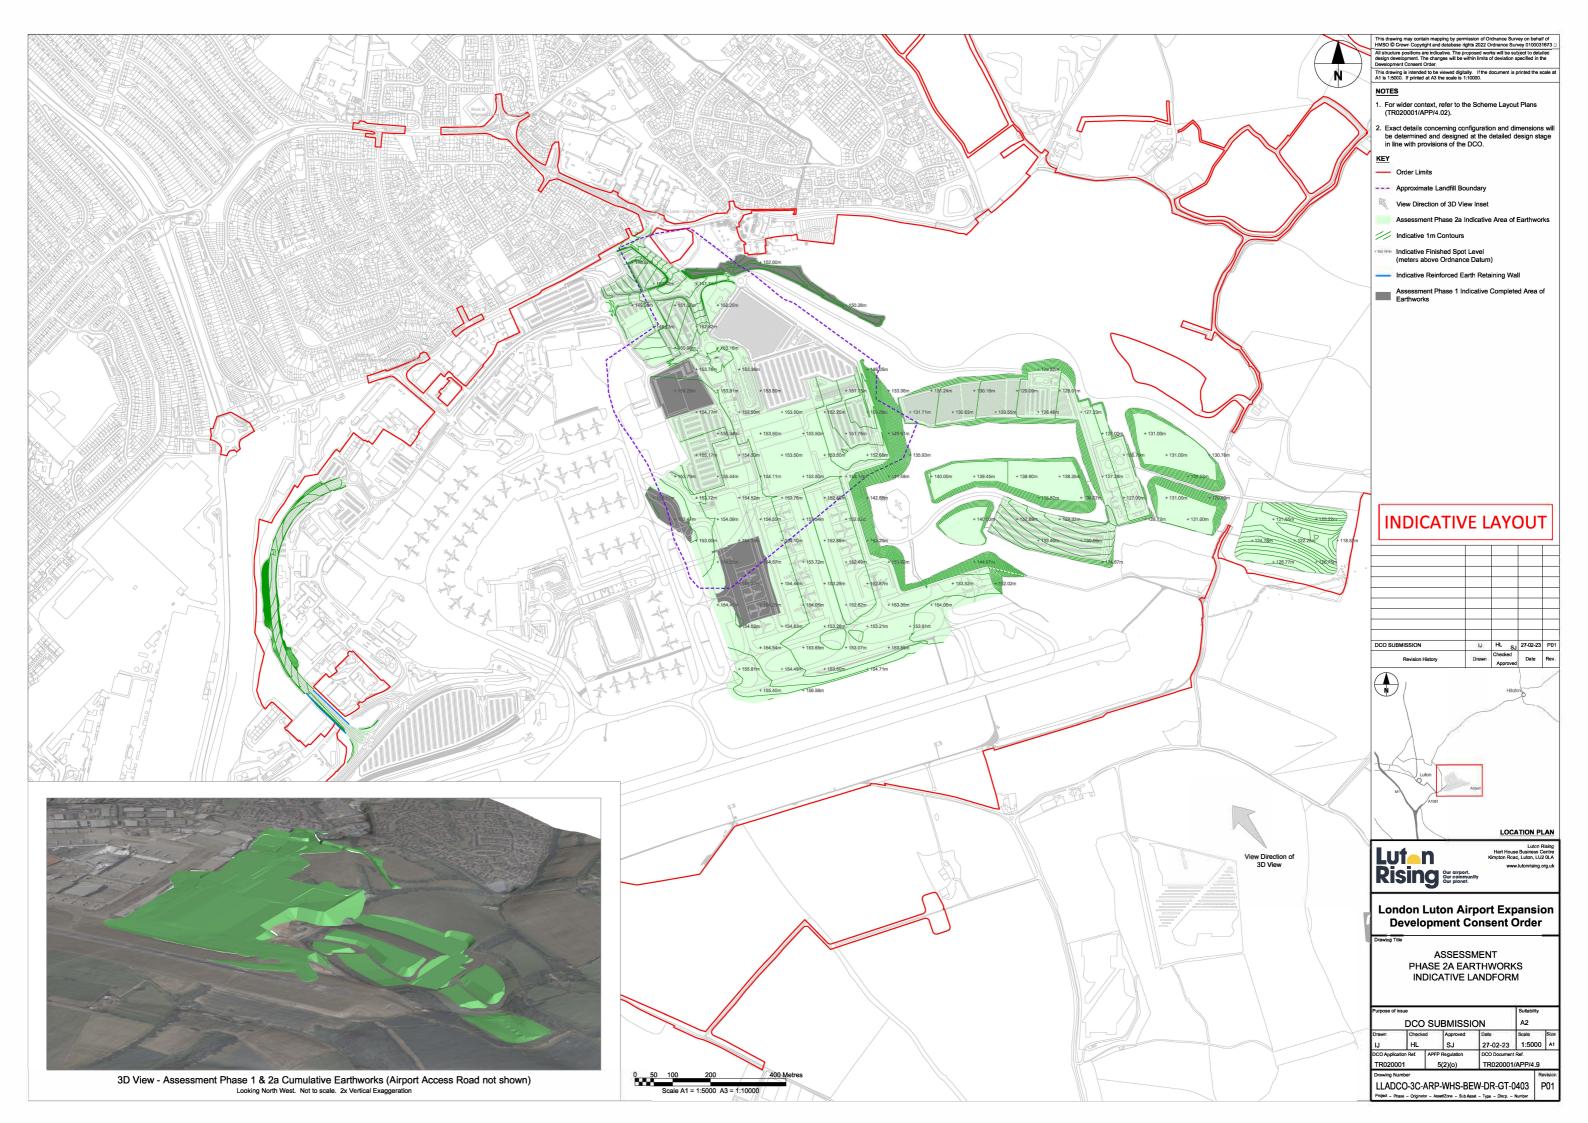

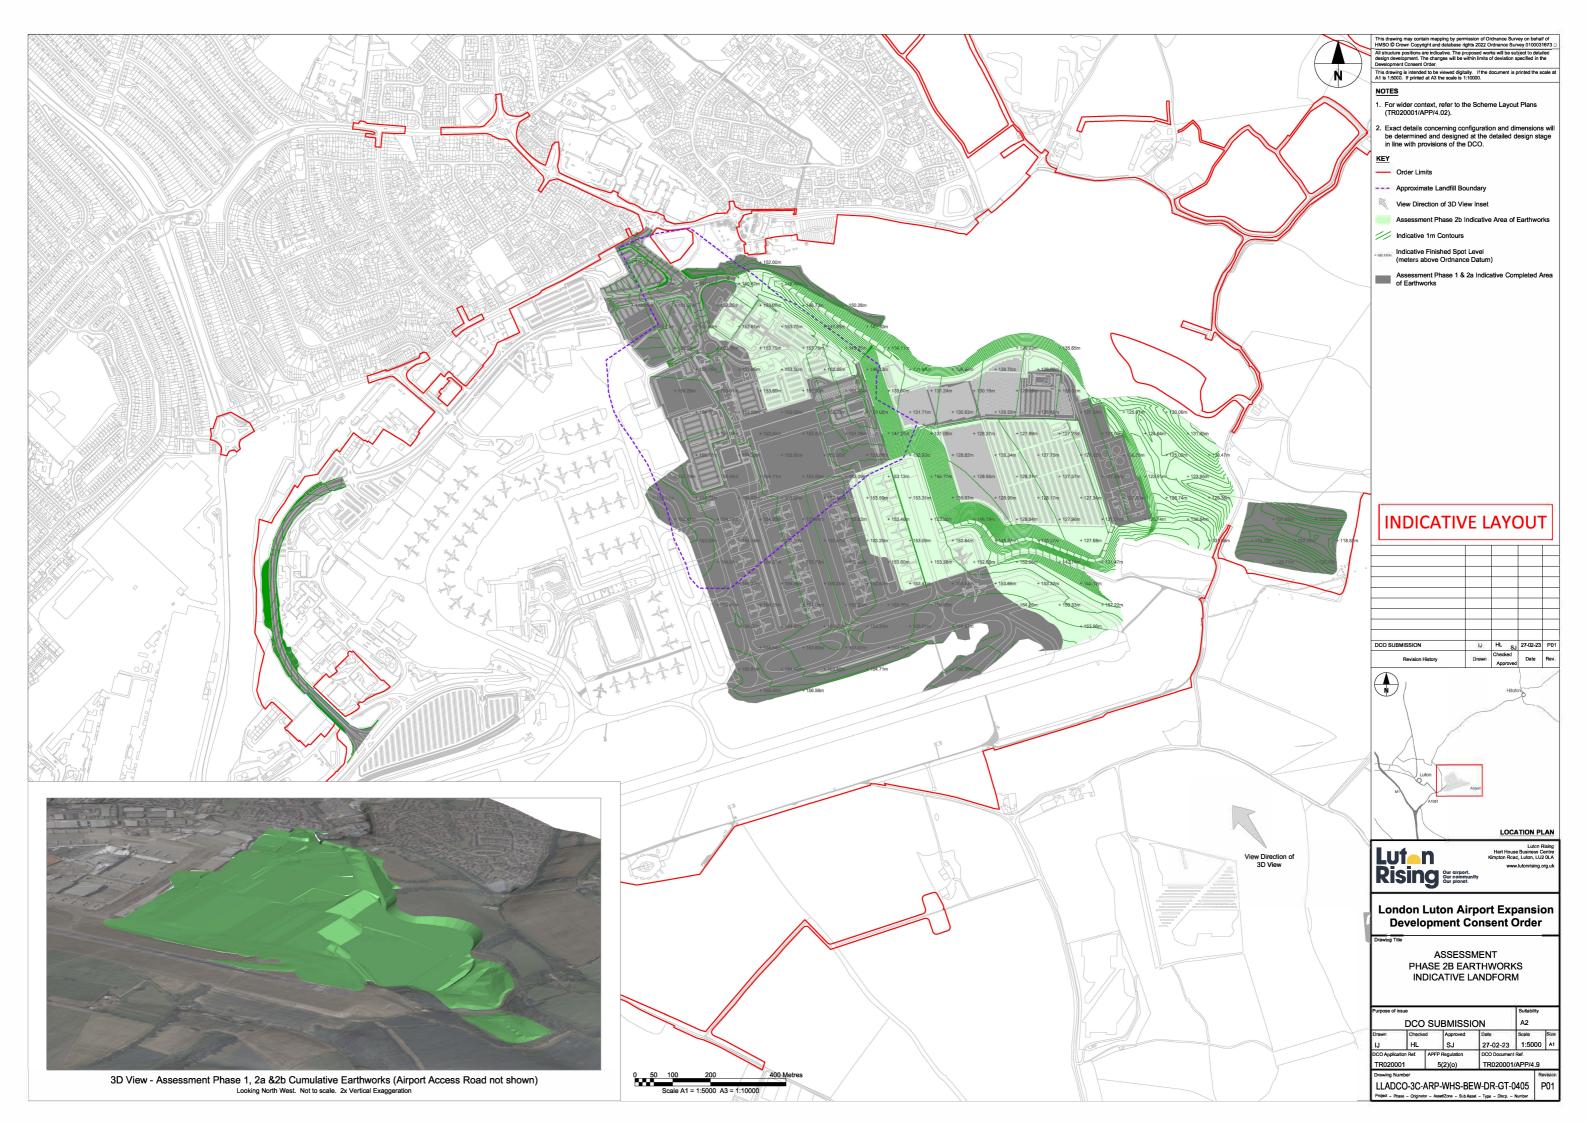

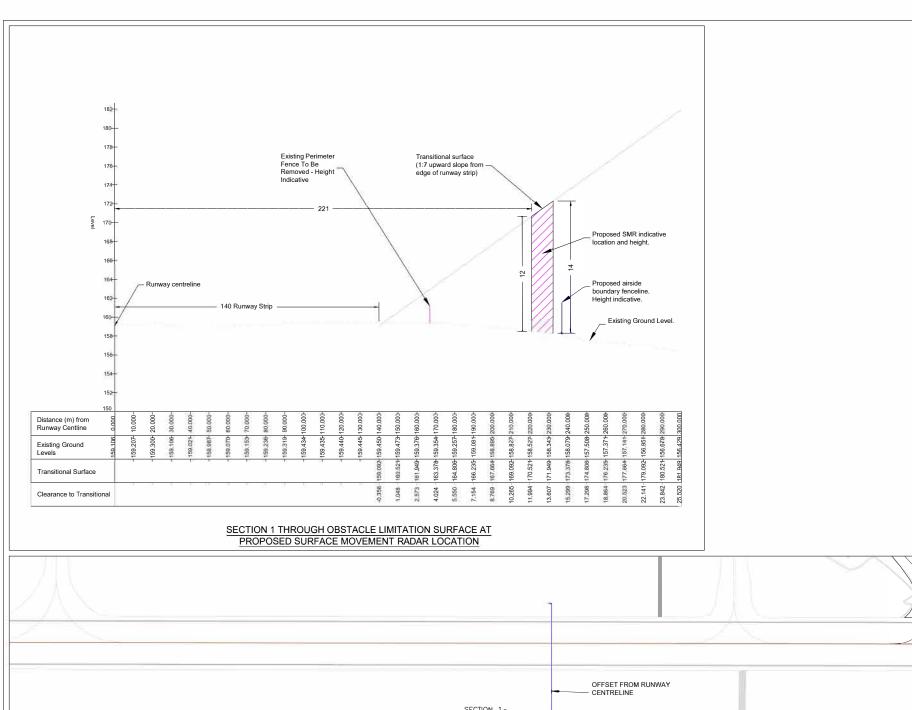

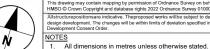

- Exact details concerning configuration and dimensions will be determined and designed at the detailed design stage in line with provisions of the DCO.
- stage in line with provisions of the IDC.
 For wider context, refer to proposed facility no.1 on the Scheme Layout Plans (TR020001/APP/4.02).
 Existing runway level information taken from London Luton Airport Aerodrome plan by SLC associates. drawing ref. CA-00-201-011 revision x, dated December 2018.

Existing airside boundary fence

Proposed airside boundary fence

Existing Access point through airside boundary fence to be retained

Obstacle Limitation Surface Transitional Slope

Proposed access road

Existing perimeter road

Proposed SMR indicative location and height

Transitional surface extents



DCO Submisson	SW	SR MS	27-02-23	P0
Revision History	Drawn	Checked Approved	Date	Rev
			~	
1 1 1 1 1 1 1 1 1 1 1 1 1 1 1 1 1 1 1	<u>e</u>			
325 32 F 38 + 1 + 1				

		417	:07777	
	A SHARE	Y.		2
**************************************	HAM -	11	Street !	
		-1	1 3	and l
				7
	1		71.97	
		LOCA	TION PL	.AN
	//		Luton	_




P01


London Luton Airport Expansion Development Consent Order

INDICATIVE SURFACE MOVEMENT RADAR PLAN & SECTION

Purpose of iss	sue				Suitability	
	DC	O SUE	BMISSIO	N	S6	
Checked Approved Date SW SR MS 27-02-23					Scale 1:2000	Size A1
		Regulation (2)(o)	TR020001//			


LLADCO-3C-ACM-AIR-MSC-DR-CE-0001

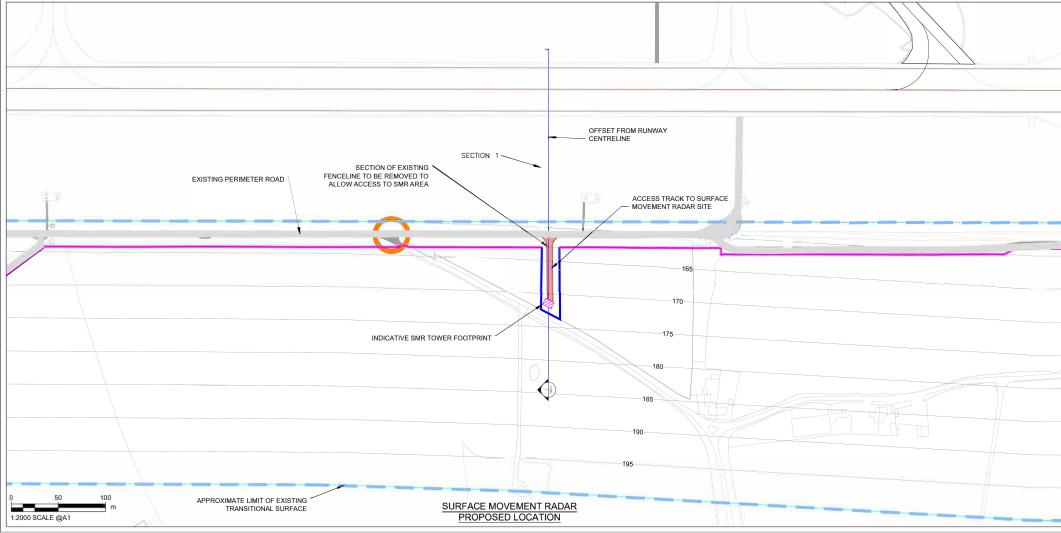

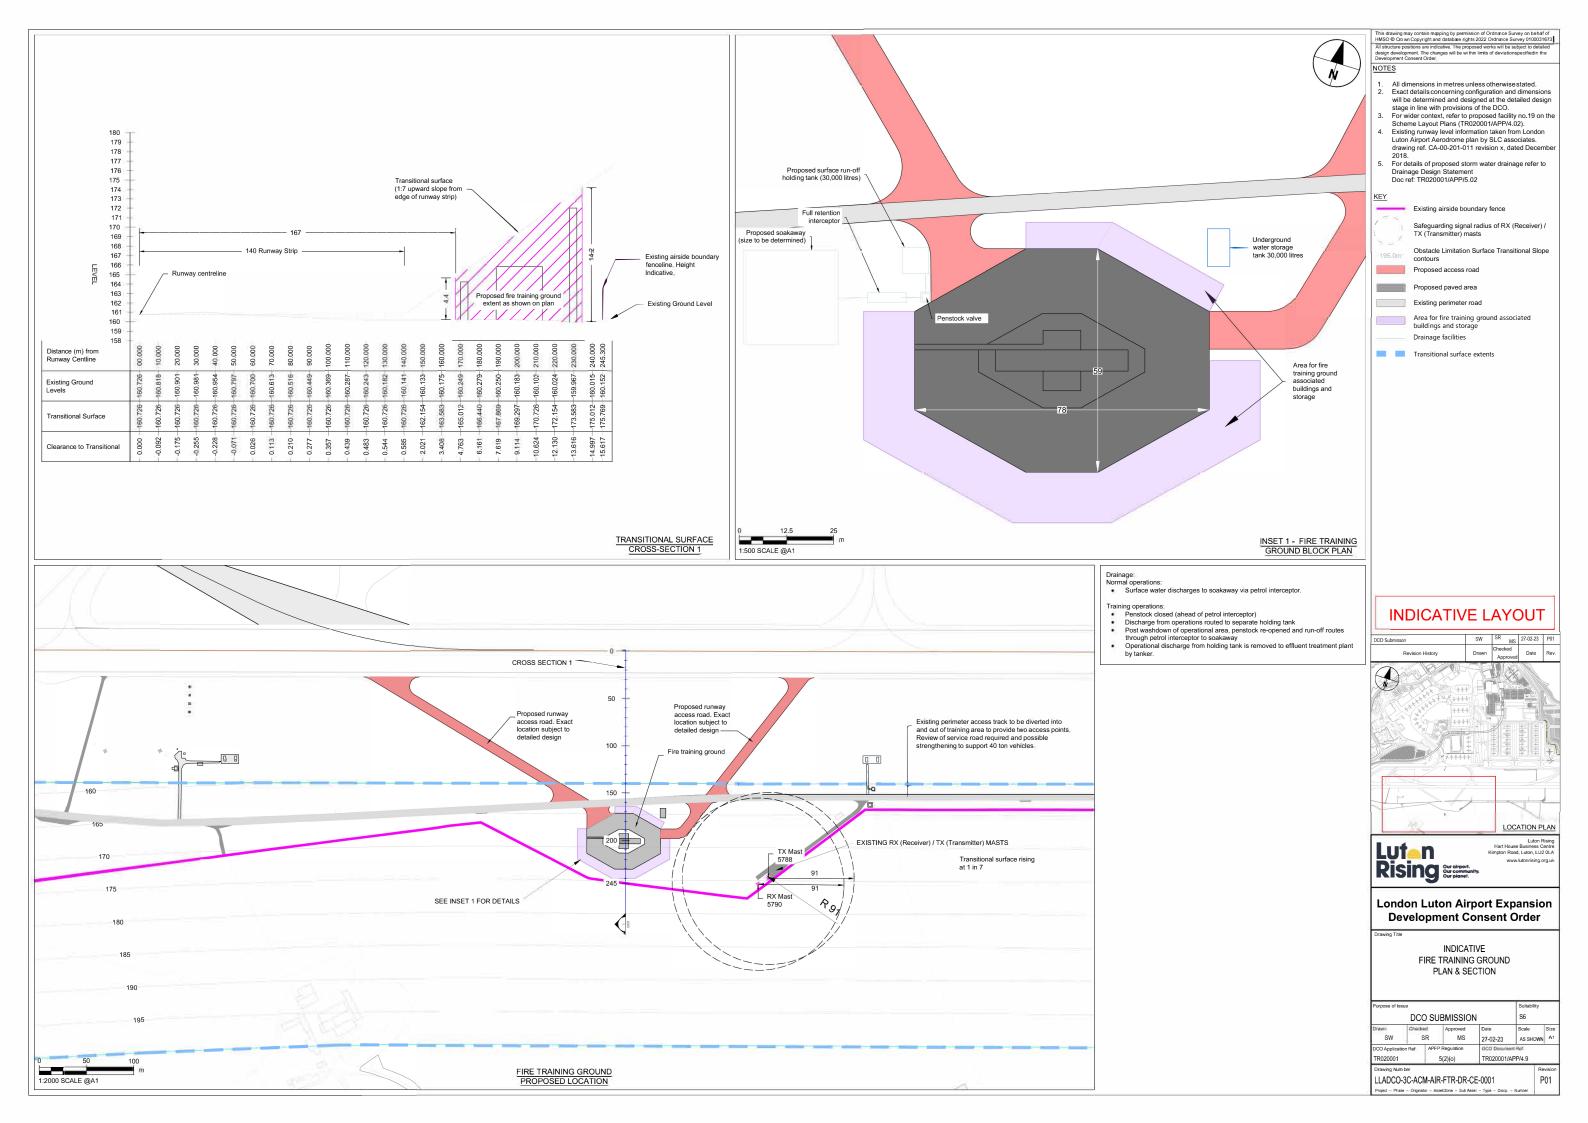



- All dimensions in metres unless otherwise stated.
 Exact details concerning configuration and dimensions will be determined and designed at the detailed design stage in line with provisions of the DCO.
 For wider context, refer to proposed facility no.12 on the Scheme Layout Plans (TR020001/APP/4.02).

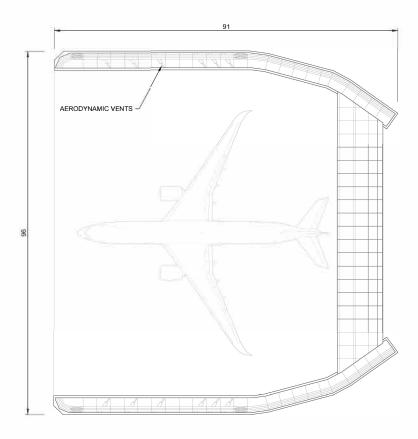


PROPOSED ENGINE RUN-UP BAY TYPICAL LAYOUT (ILLUSTRATIVE)




TYPICAL LONG SECTION THROUGH AIRCRAFT CENTRELINE SCALE 1:500



FRONT ELEVATION SCALE 1:500

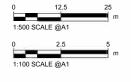

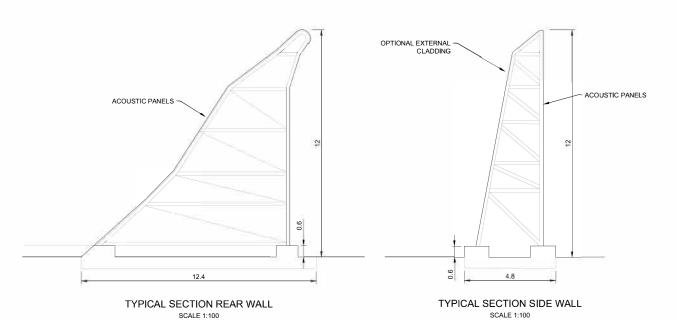

INDICATIVE LAYOUT

DCO Submisson	SW	SR MS	27-02-23
Revision History	Drawn	Checked Approved	Date
CN		F-V	W.

++++ A	7/-		
		5 72 8	
LIE			
Section (1) 4 (1)			




LOCATION PLAN


London Luton Airport Expansion Development Consent Order

INDICATIVE ENGINE RUN-UP BAY PLAN & SECTION


Purpose of is	sue				Suitability	,
	DC	o si	JBMISSIO	N	S6	
Drawn	Check	ed. SR	Scale 1:5000	Size A1		
		P Regulation 5(2)(o)	TR020001//			
Denvise Abo		_				Davisias

LLADCO-3C-ACM-AIR-ENG-DR-CE-0001 P01

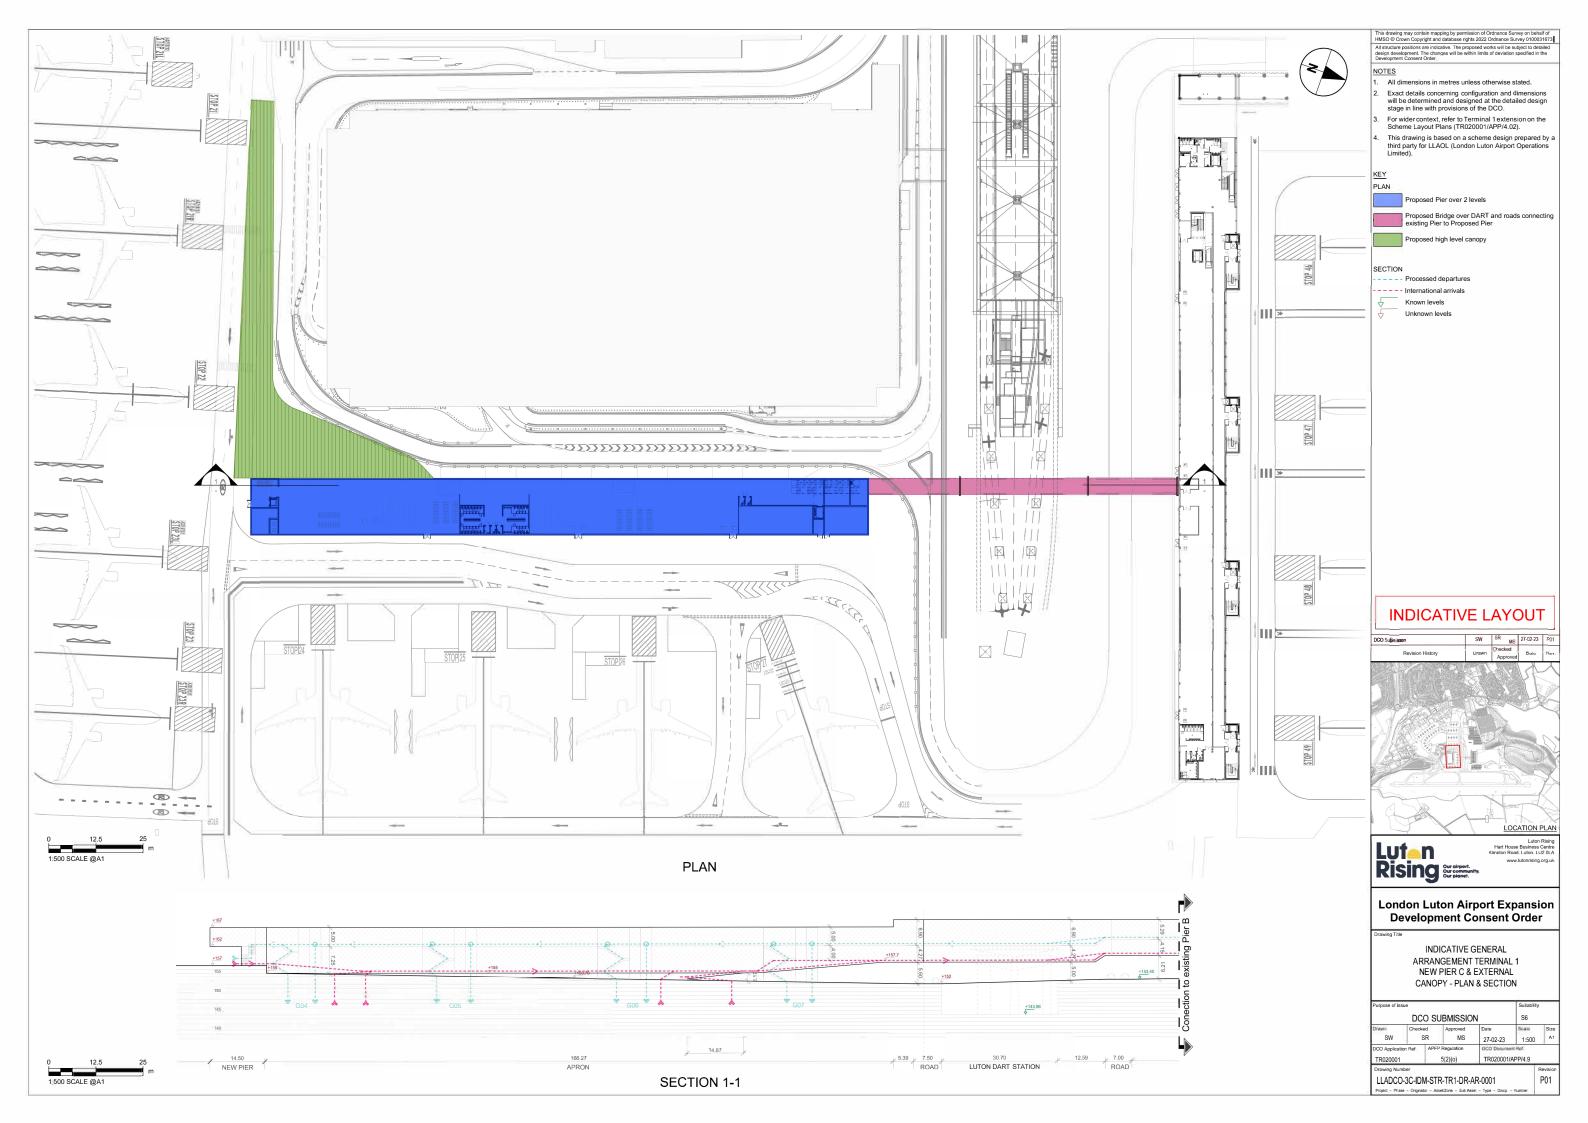

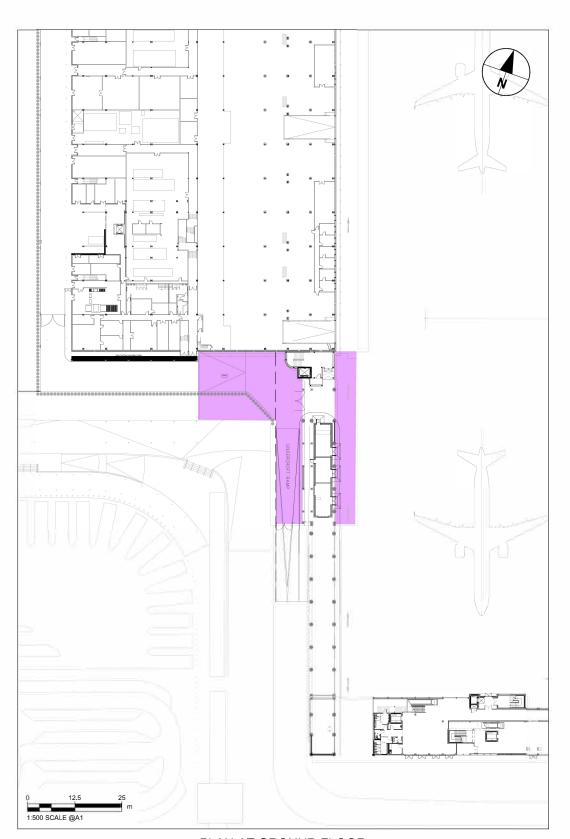

PLAN AT GROUND FLOOR

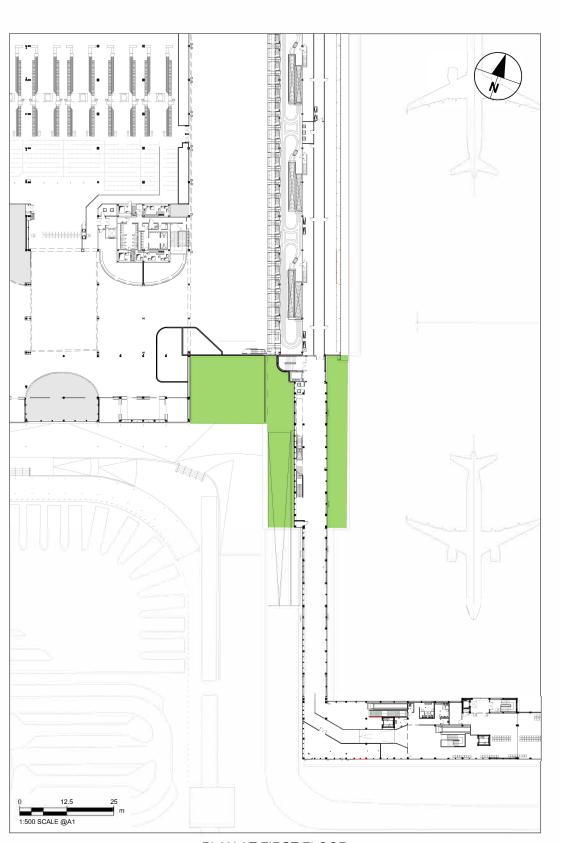

PLAN AT FIRST FLOOR

- Exact details concerning configuration and dimensions will be determined and designed at the detailed design stage in line with provisions of the DCO.
 For wider context, refer to Terminal 1 extension on the Scheme Layout Plans (TR020001/APP/4,02).
- This drawing is based on a scheme design prepared by a third party for LLAOL (London Luton Airport Operations Limited).

Extension at Ground Floor

Extension at First Floor

INDICATIVE LAYOUT

DCO Submisson	SW	SR MS	27-02-23	P0
Revision History	Drawn	Checked Approved	Date	Re
			1	
			N/	
				1
			2	
				^
	1-			
The state of the s	4	W.		1.30
/#January /				7
/#January /				
/#January /				





London Luton Airport Expansion Development Consent Order


INDICATIVE GENERAL ARRANGEMENT TERMINAL 1 SOUTH EXTENSION


Purpose of issue					Suitability	
	DC	O SU	BMISSIO	N	S6	
Drawn SW	Check	ed SR	Approved MS	Date 27-02-23	Scale 1:500	Siz
DCO Applicati TR020001			DCO Docume TR020001/			
D	h					


LLADCO-3C-IDM-STR-TR1-DR-AR-0004

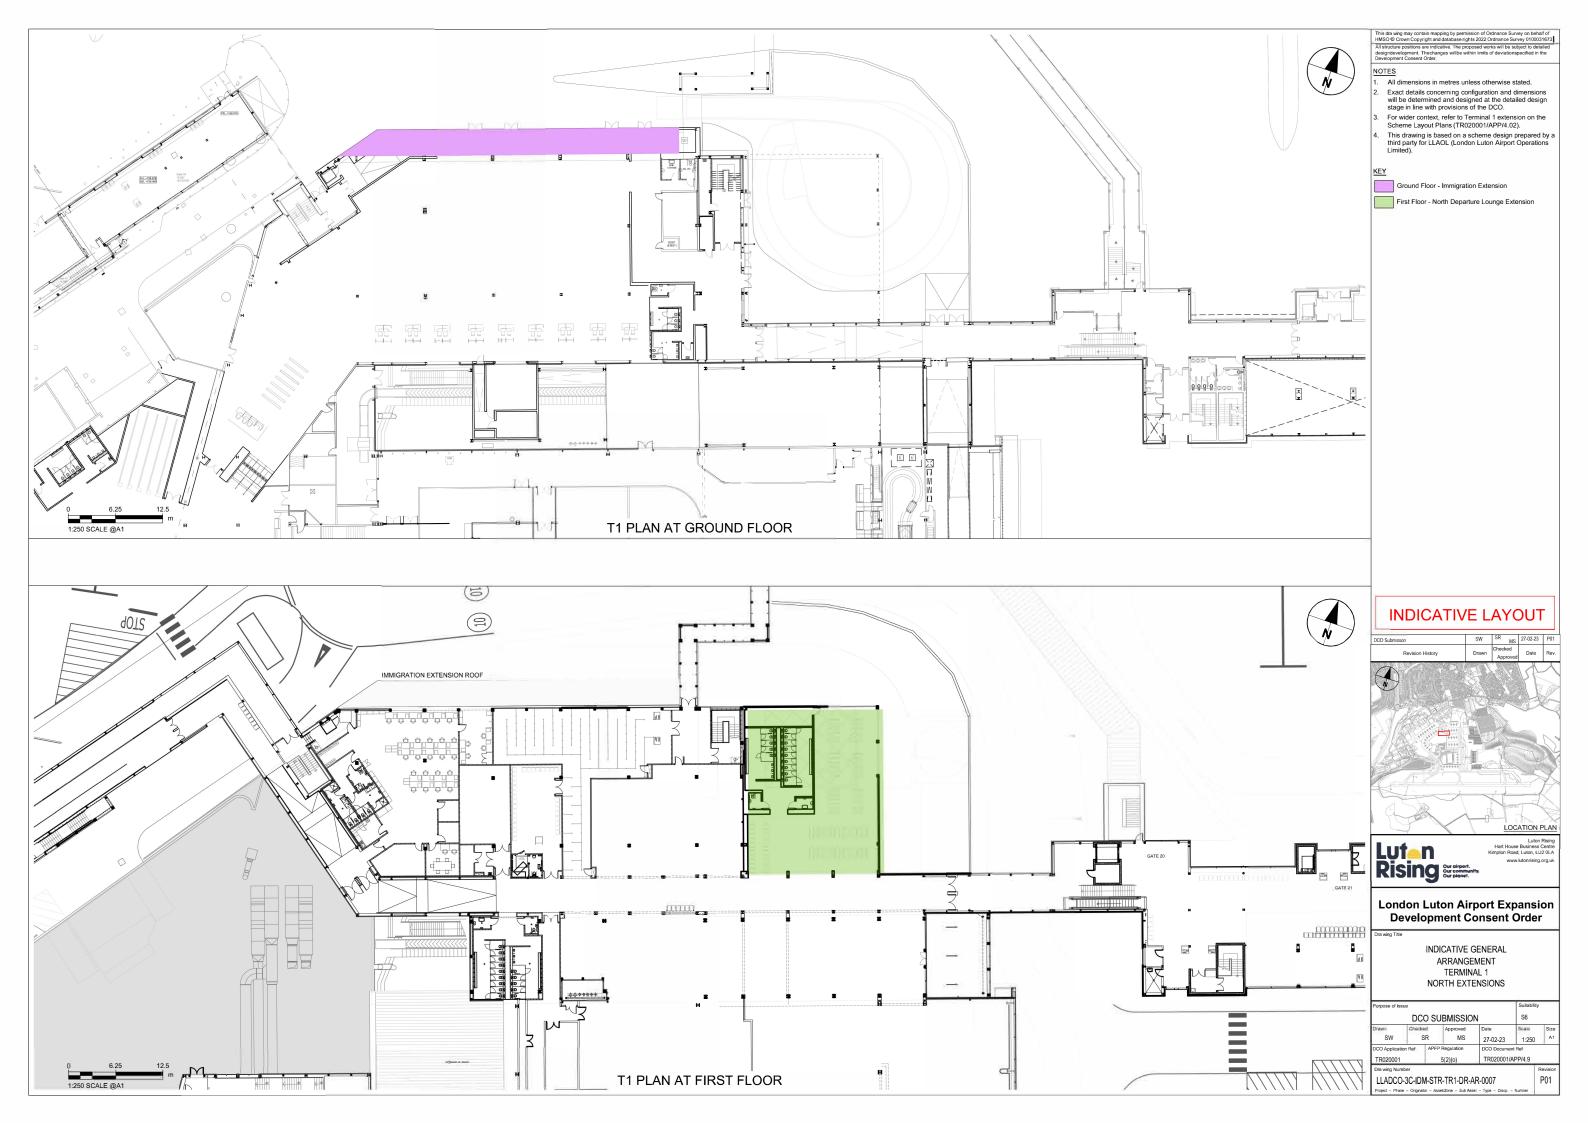


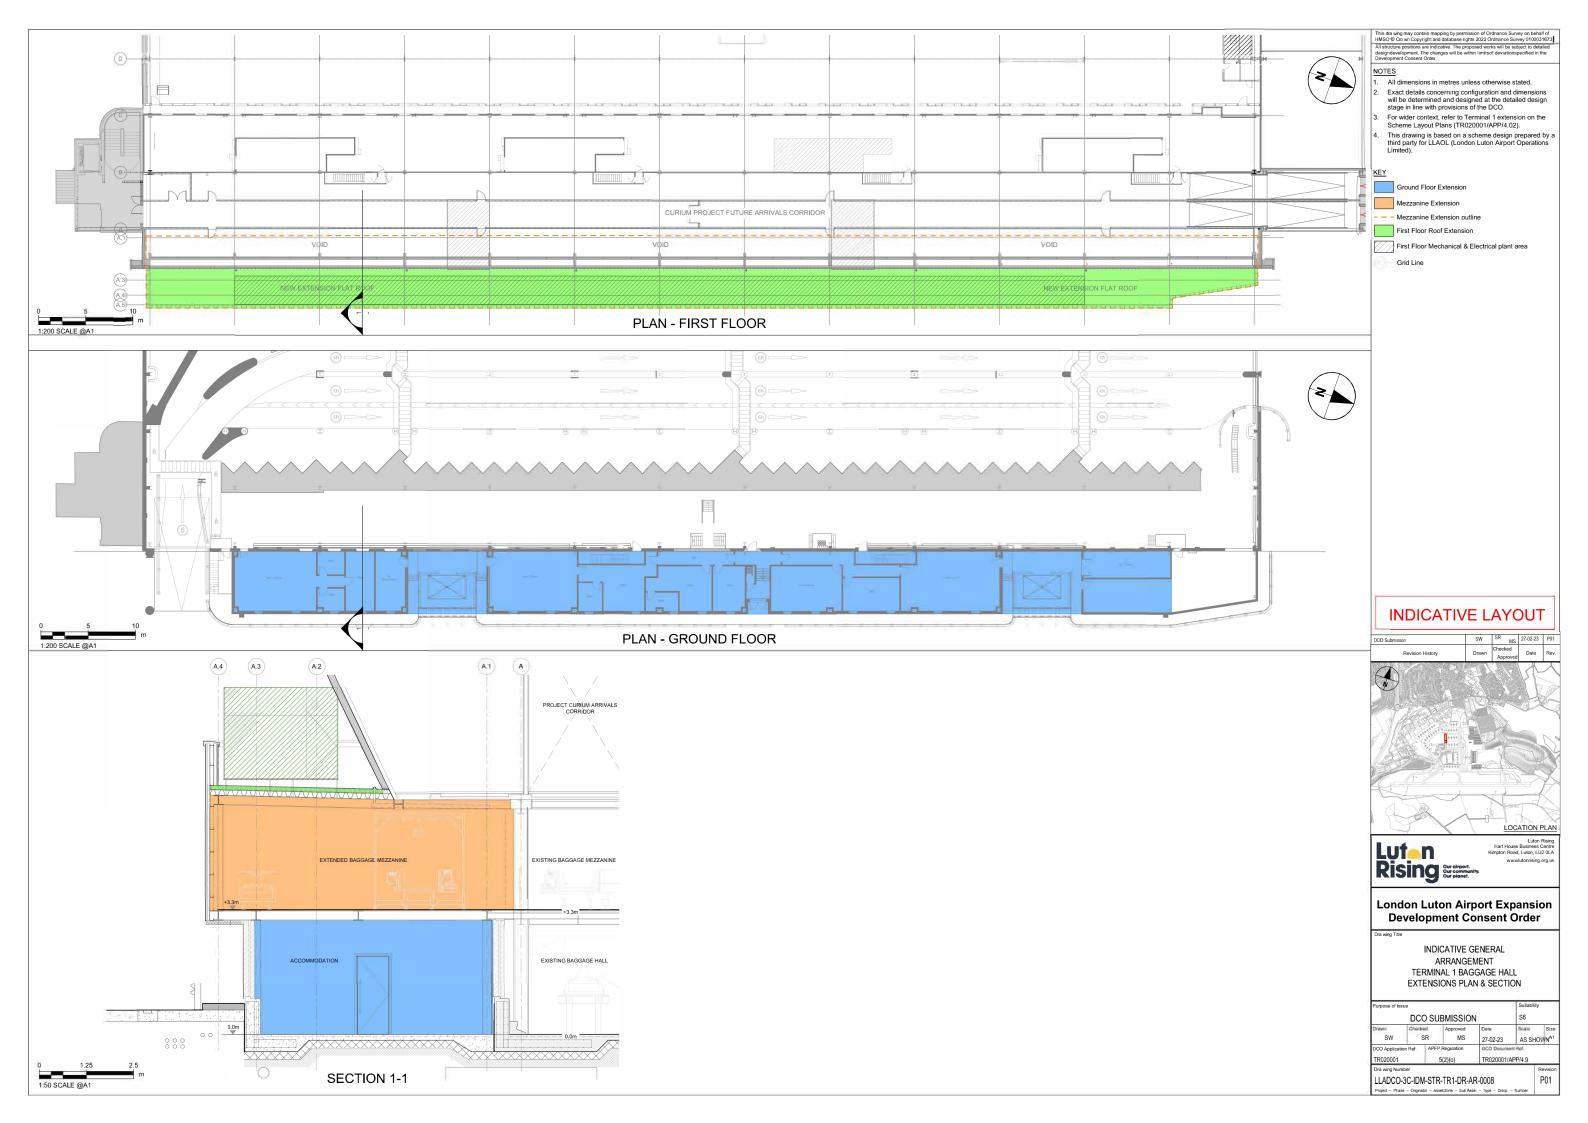

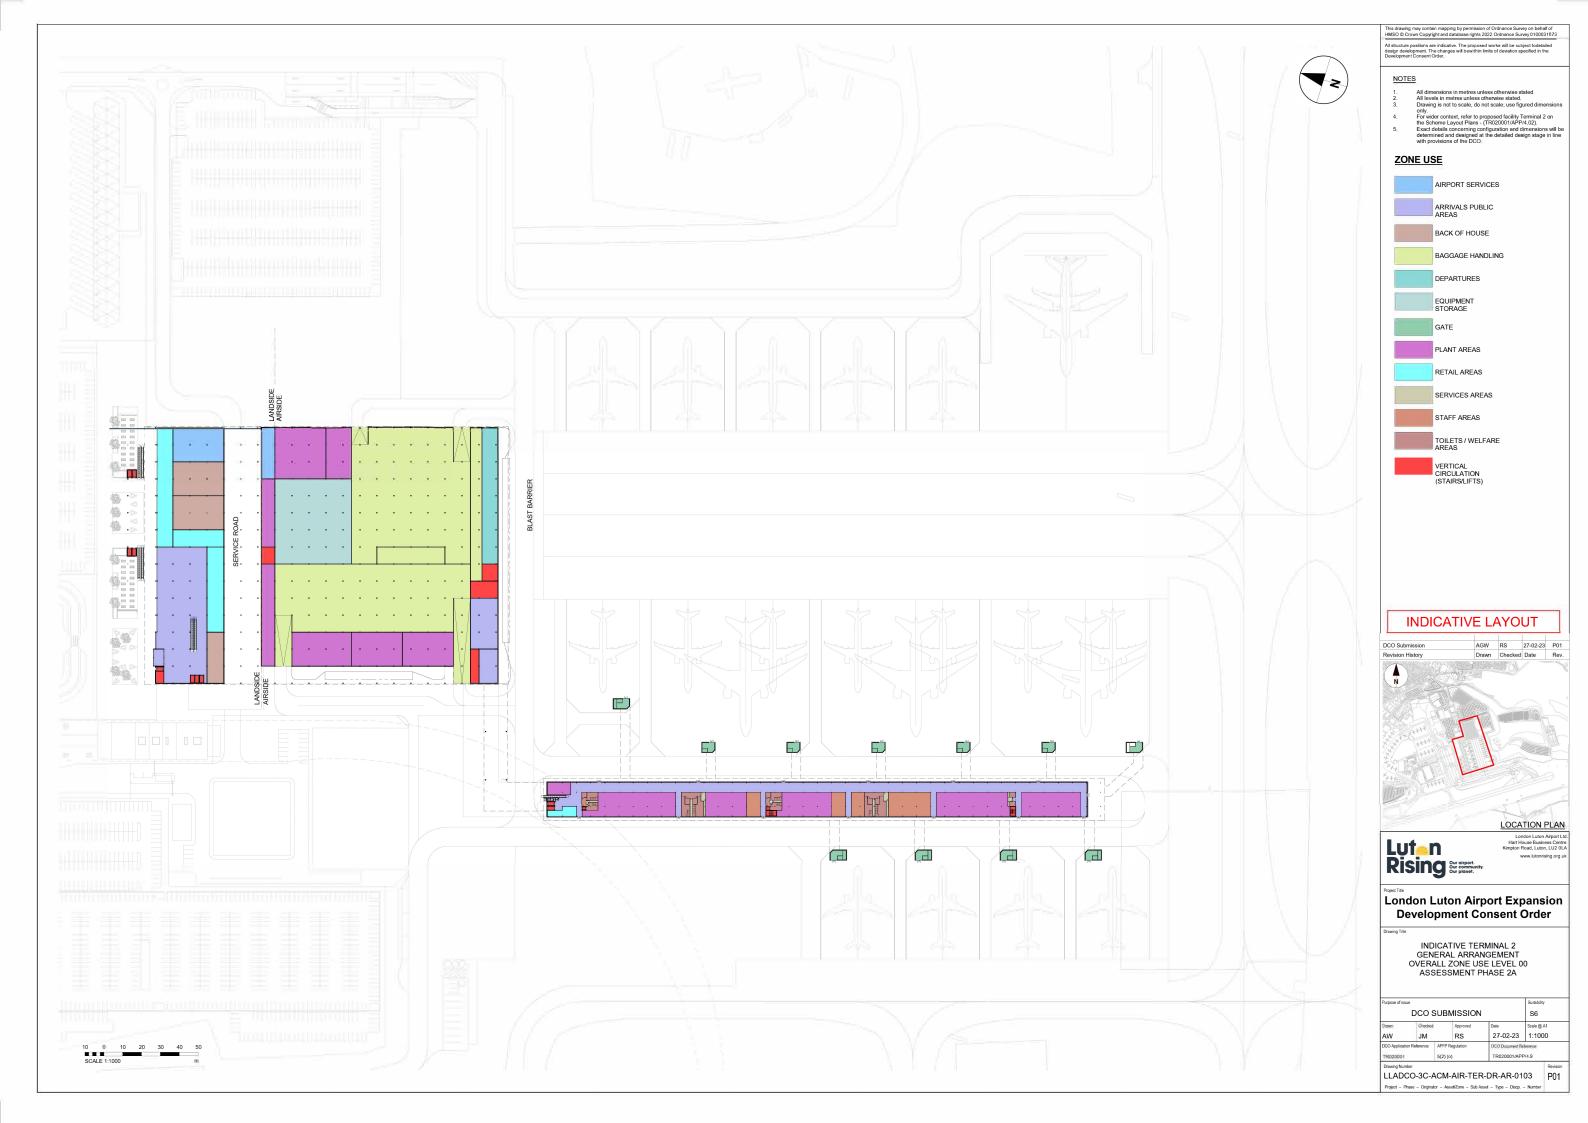


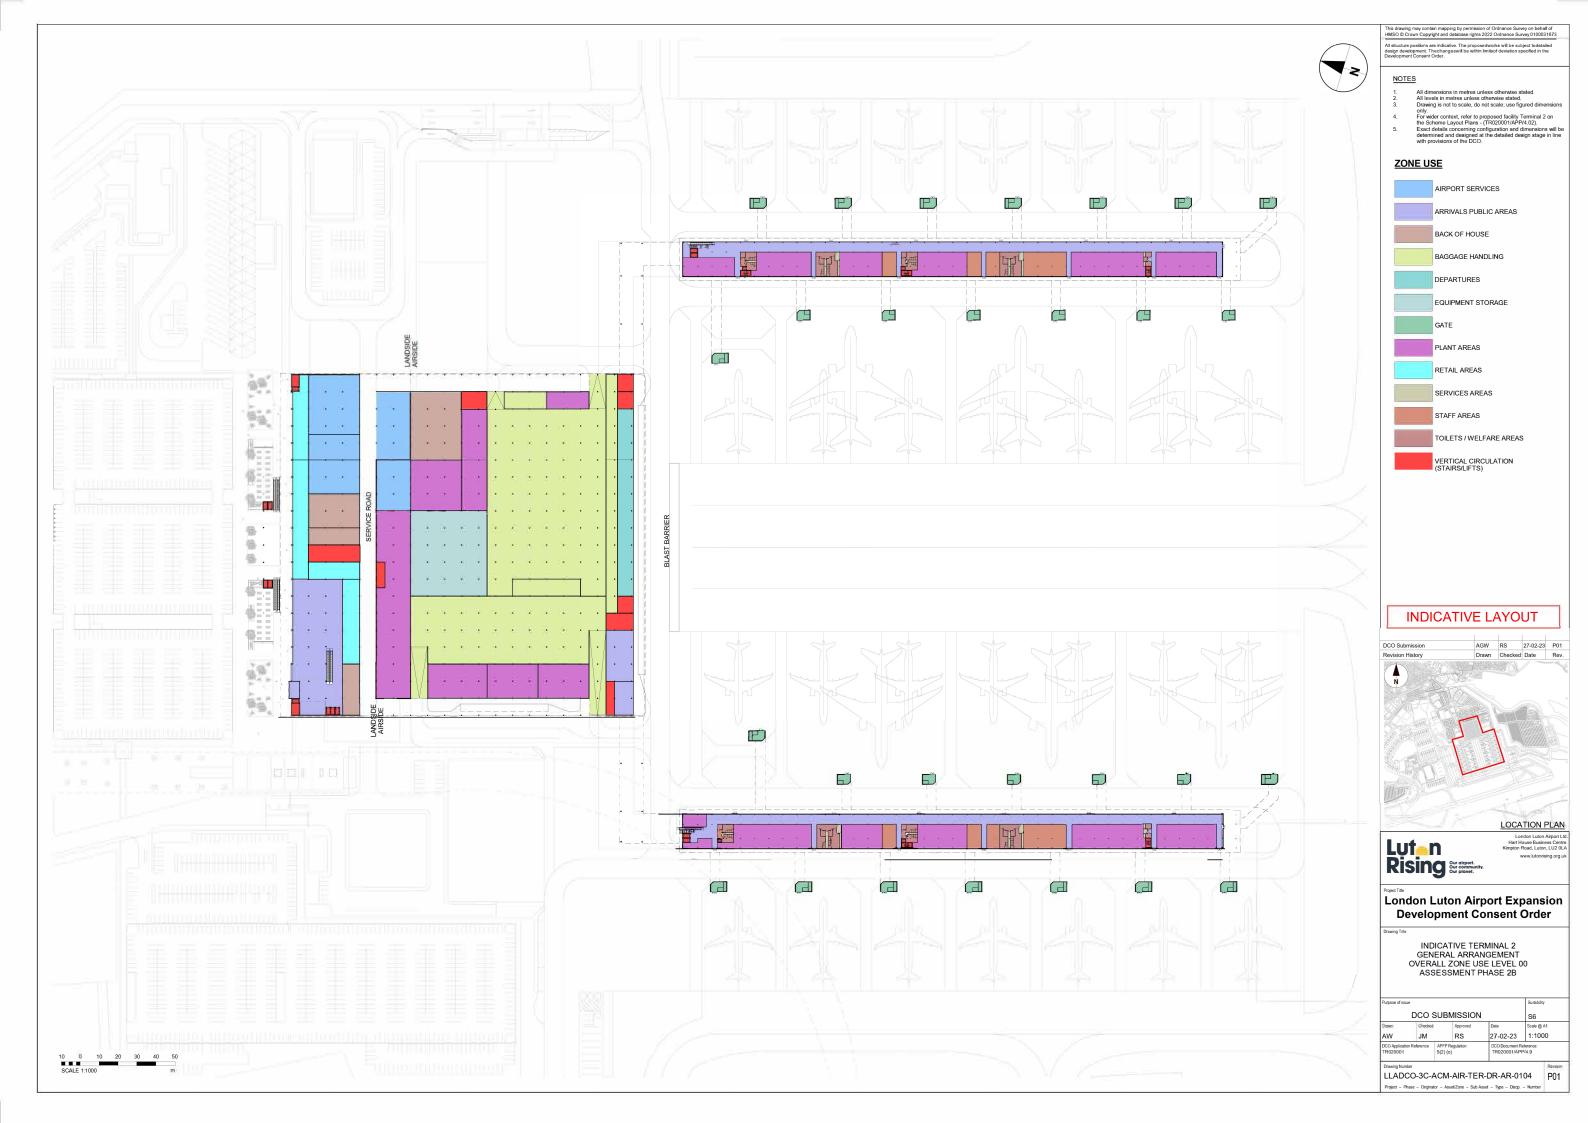

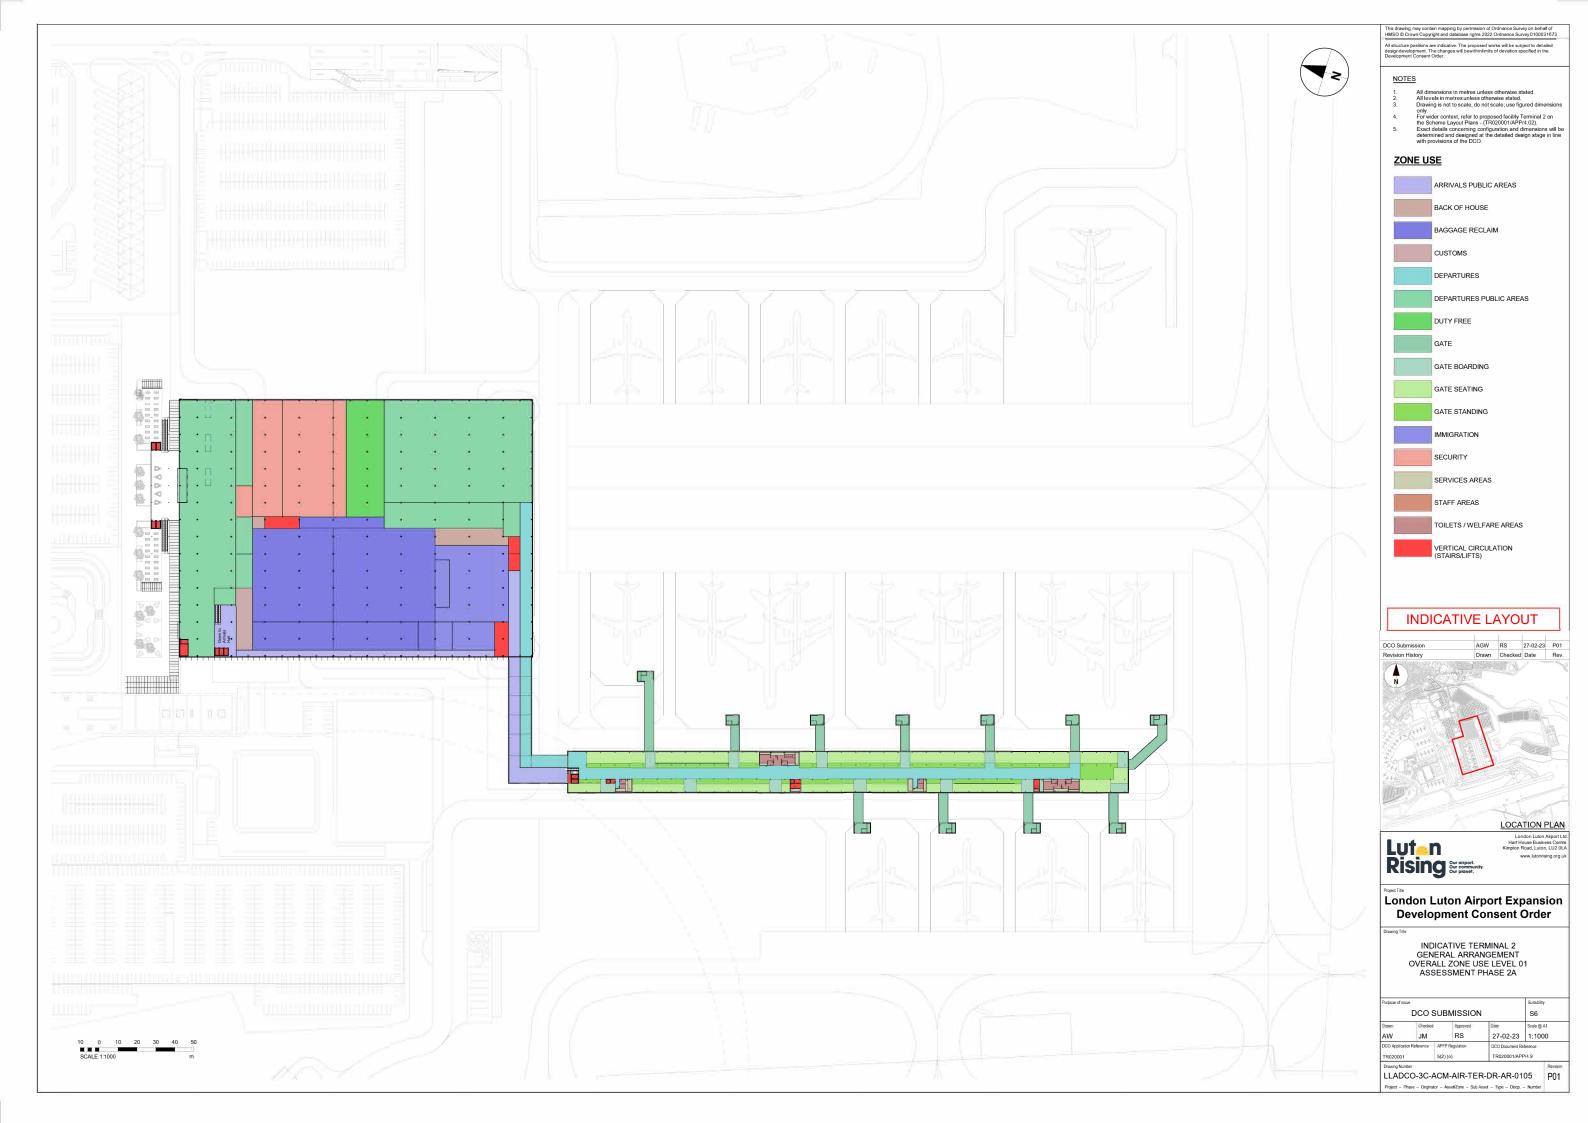

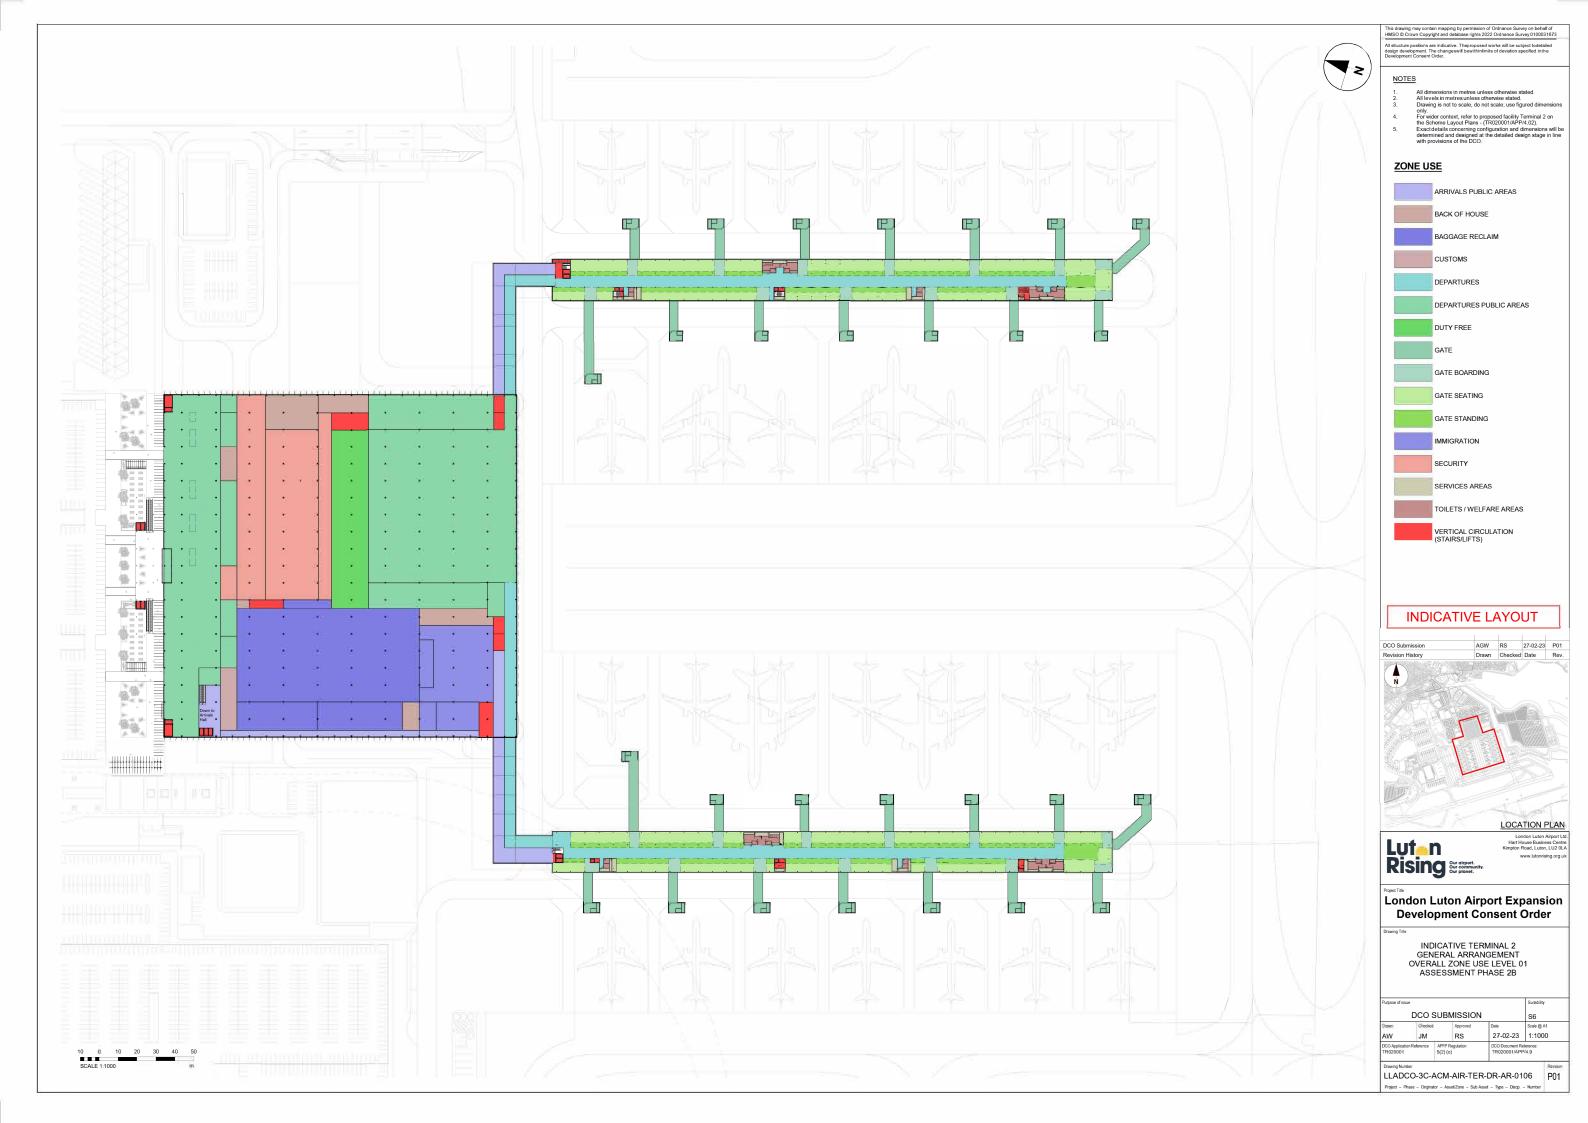



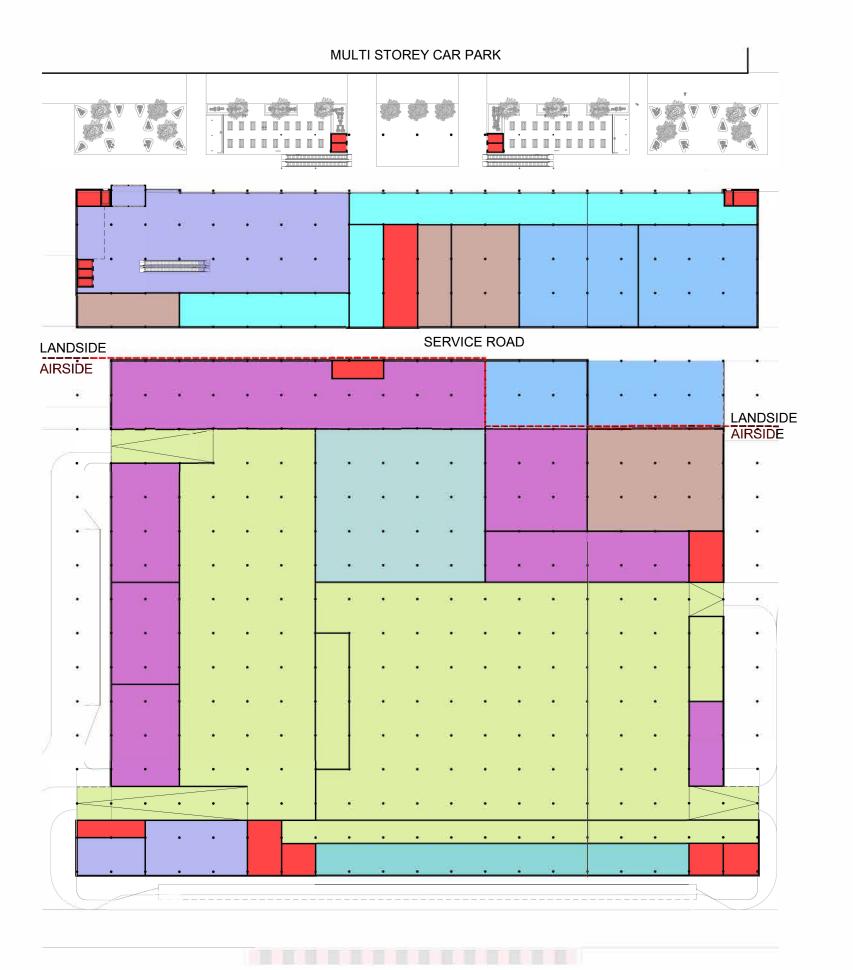



This drawing may contain mapping by permission of Ordnance Survey on behalf of HMSO @ Crown Copyright and database rights 2022 Ordnance Survey 0100031673

NOTES

- All dimensions in metres unless otherwise stated.
 All levels in metres unless otherwise stated.
 Drawing is not to scale, to not scale; use figured dimensions only.
 For wider context, refer to proposed facility Terminal 2 on the Scheme Layout Plans. (TRQ20001/APPI4.02).
 Exact details concerning configuration and dimensions will be determined and designed at the detailed design stage in line with provisions of the DCO.

ZONE USE



RETAIL AREAS

VERTICAL CIRCULATION (STAIRS/LIFTS)

INDICATIVE LAYOUT

DCO Submission	AGW	RS	27-02-23	P01
Revision History	Drawn	Checked	Date	Rev.
THE STATE OF THE S	See Level	(A)	/	
	(A. D. W			-
N	200			
	OBA .			
				C *
	CAN THE STATE OF			
A CHIEF OF THE				
SE SECTION OF THE SEC				
ALCONOMIC ARRESTS				
PHHA C		3		
				d'h
99 LINE 1				
additional and the Hamiltonian				
		0 -		
				1
		-	1000	
		LOCA	TION F	PLAN



London Luton Airport Expansion **Development Consent Order**

INDICATIVE TERMINAL 2 GENERAL ARRANGEMENT
MAIN BUILDING ZONE USE LEVEL 00 ASSESSMENT PHASE 2B

sue			Surtability		
DCO SUBMISSION					
Drawn Checked		Date	Scale @ A1		
JM	RS	27-02-23	1:500		
	DCO Checker JM	DCO SUBMISSION Checked Approved JM RS	DCO SUBMISSION Date Date		

LLADCO-3C-ACM-AIR-TER-DR-AR-0108 P01





This drawing may contain mapping by permission of Ordnance Survey on behalf of HMSO @ Crown Copyright and database rights 2022 Ordnance Survey 0100031673

NOTES


All dimensions in metres unless otherwise stated All levels in metres unless otherwise stated. Drawing is not to scale, do not scale; use figured dimensions

Drawing is not to scate, on not scate, use rigored unimisturs only For wider context, refer to proposed facility Terminal 2 on the Scheme Layout Plans - (TR020001/APP4.02). Exact details concerning configuration and dimensions will be determined and designed at the detailed design stage in line with provisions of the DCO.

ZONE USE





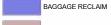

















INDICATIVE LAYOUT

DCO Submission	AGW	RS	27-02-23	P01
Revision History	Drawn	Checked	Date	Rev
PT 10.00	-745-44115	A THE	1	
	Profit and			
N	CHE			
0.00	Valley of the second			
	Salutitium .			
XIII XXXXXXXXXXXXXXXXXXXXXXXXXXXXXXXXX	C) Illiandin	- THE RESIDENCE OF THE PARTY OF	MINISTER OF THE PARTY NAMED IN	
	nis and the	1	March III/	1
	11111			da
N. K. K. T. S. W.				
444		0 /=		193
XX FFFF				
*			7	927
77 48 11 11 11 11				
THE		X.		
million and a second				
111111111111111111111111111111111111111		100		-

LOCATION PLAN





London Luton Airport Expansion **Development Consent Order**

INDICATIVE TERMINAL 2 GENERAL ARRANGEMENT MAIN BUILDING ZONE USE LEVEL 01 ASSESSMENT PHASE 2A


Purpose of issue				
DCO SUBMISSION				S6
Drawn	Checked	d Approved	Date	Scale @ A1
AW	JM	RS	27-02-23	1:500
DCO Applicat	ion Reference	APFP Regulation	DCO Document Re	ference.
TR020001		5(2) (o)	TR020001/APF	9/4.9

LLADCO-3C-ACM-AIR-TER-DR-AR-0109 P01

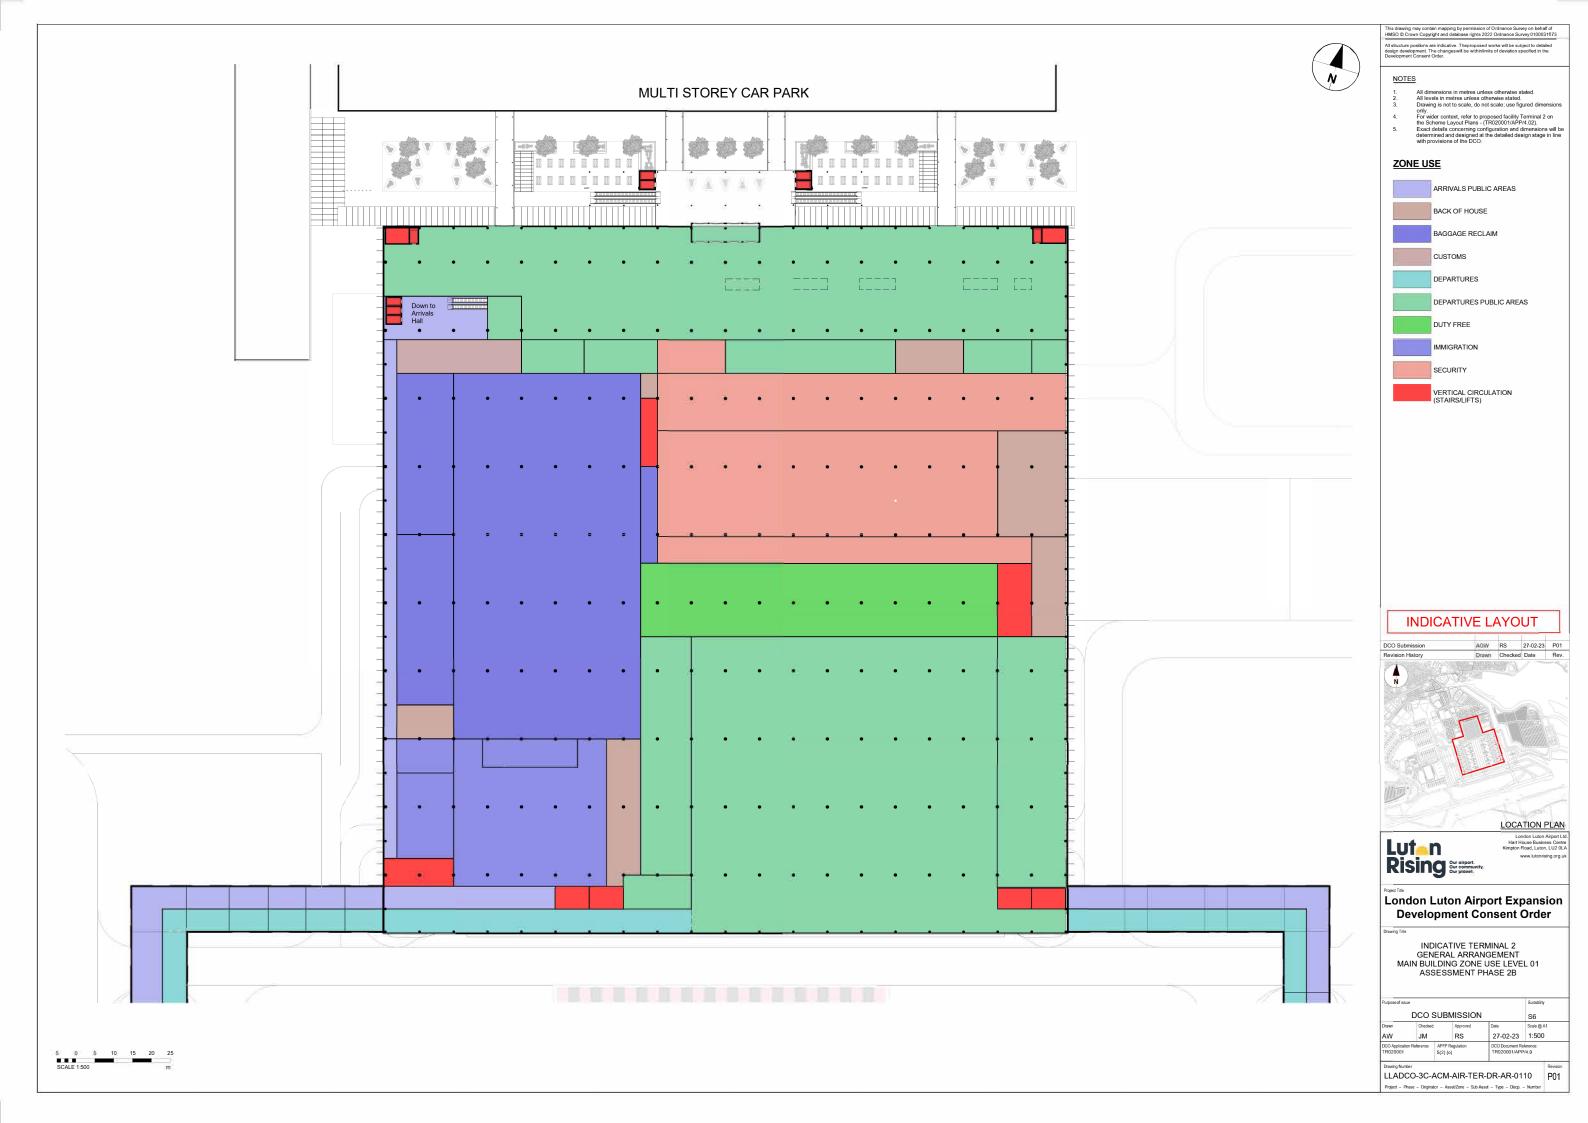


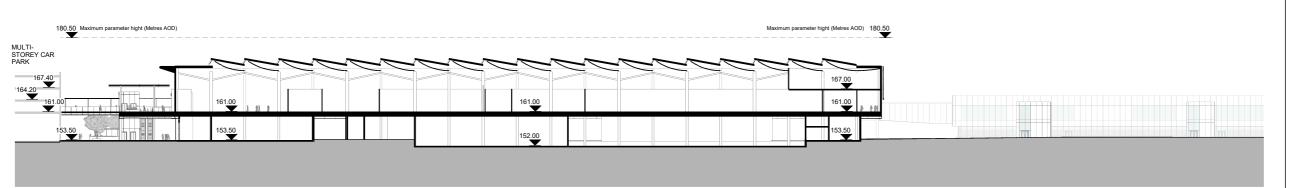

1 ASSESSMENT PHASE 2B - TERMINAL 2 CROSS SECTION 1 SCALE: 1:500

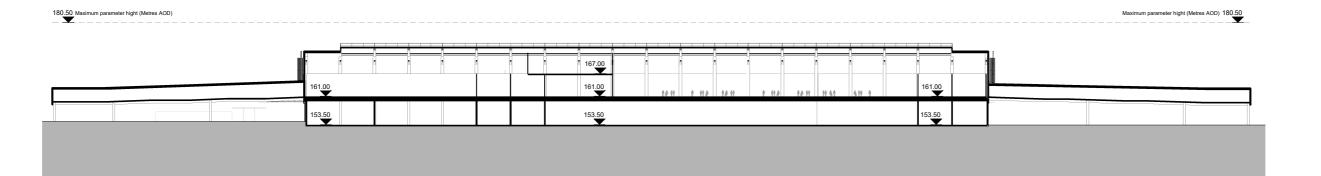

2 ASSESSMENT PHASE 2B - TERMINAL 2 CROSS SECTION 2 SCALE: 1:500

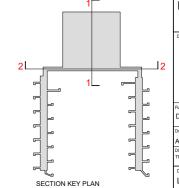

This drawing may contain mapping by permission of Ordnance Survey on behalf of HMSO © Crown Copyright and database rights 2022 Ordnance Survey 0100031673


only.

4. For wider context, refer to proposed facility Terminal 2 on the Scheme Layout Plans - (TR02001/APP4 0.2).

5. Exact details concerning configuration and dimensions will be determined and designed at the detailed design stage in line with provisions of the DCO.

LEVEL RELATIVE TO SEA LEVEL IN METRES

INDICATIVE LAYOUT

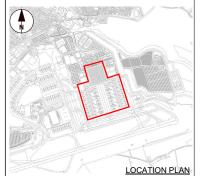

Luten Rising Our cirport, Our community.


London Luton Airport Expansion **Development Consent Order**

INDICATIVE TERMINAL 2 CROSS SECTIONS ASSESSMENT PHASE 2B


turpose of issue	Suitability S6	,				
rawn AW	Checked JM		Approved RS	Date 18-11-22	Scale @ # 1:500	
ICO Application Reference APFP Re TR020001 5(2) (o)				CO Document Reference: 'R020001/APP/4.9		
Dannian Mumber						Davisias

LLADCO-3C-ACM-AIR-TER-DR-AR-0401 P01

5 0 5 10 15 20 25 SCALE 1:500 m

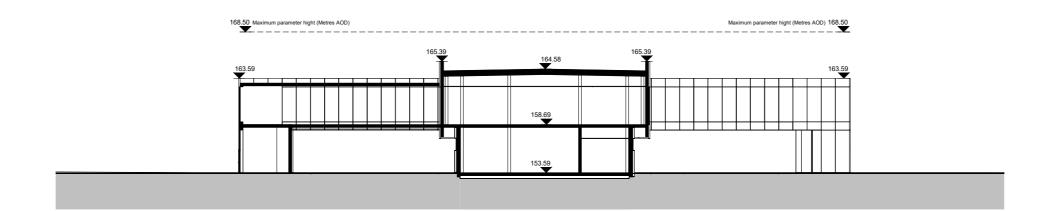


INDICATIVE TERMINAL 2 EAST PIER CROSS SECTION

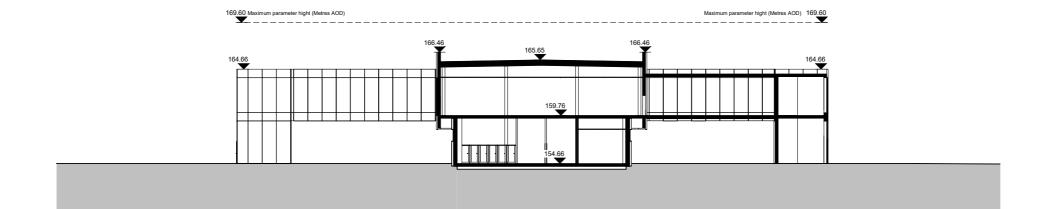

INDICIATIVE TERMINAL 2 WEST PIER CROSS SECTION

SCALE: 1:200

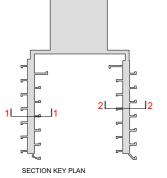


This drawing may contain mapping by permission of Ordnance Survey on behalf of HMSO © Crown Copyright and database rights 2022 Ordnance Survey 0100031673

only.

For wider context, refer to proposed facility Terminal 2 on the Scheme Layout Plans - (TR020001/APP/4.02). Exact details concerning configuration and dimensions will be determined and designed at the detailed design stage in line with provisions of the DCO.

LEVEL RELATIVE TO SEA LEVEL IN METRES

INDICATIVE LAYOUT

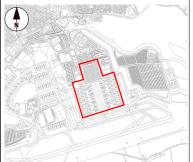

LOCATION PLAN

Luten Rising Our cirport, Our community.

London Luton Airport Expansion **Development Consent Order**

INDICATIVE TERMINAL 2 PIER CROSS SECTIONS ASSESSMENT PHASE 2B

irpose of issue					Suitability
CO SUBN	S6				
awn	Checked		Approved	Date	Scale @ A1
W	JM		RS	18-11-22	1:200
CO Application Reference R020001 APFP Re 5(2) (o)		gulation	DCO Document Ref TR020001/APP		

LLADCO-3C-ACM-AIR-TER-DR-AR-0402 P01

2 0 2 4 6 8 10 SCALE 1200 m




DCO Submission	AGW	RS	27-02-23	P01
Revision History	Drawn	Checked	Date	Rev.
107 Hhz	A WORLD AND STORY	(C. 1888)	//	
	100 to 10	SAR CA		1
N /	Contract of the Contract of th			
	THE THE			
	(Elman)			
	Hair Election	See Manual III		
MY COMPLETE			WHITE OF	
Secretary Barren				
SEE SEE SEE SEE		3 24		
				8
199 - 19 - 16				
HHHHA				
2/1/		0 0		
			110000	

LOCATION PLAN

London Luton Airport Expansion

DCO SI	Suitability			
	S6			
Drawn Checked		Approved	Date	Scale @ A1
AW	JM	RS	27/02/23	1:500
		APFP Regulation 5(2) (o)	DCO Document R TR020001/AP	

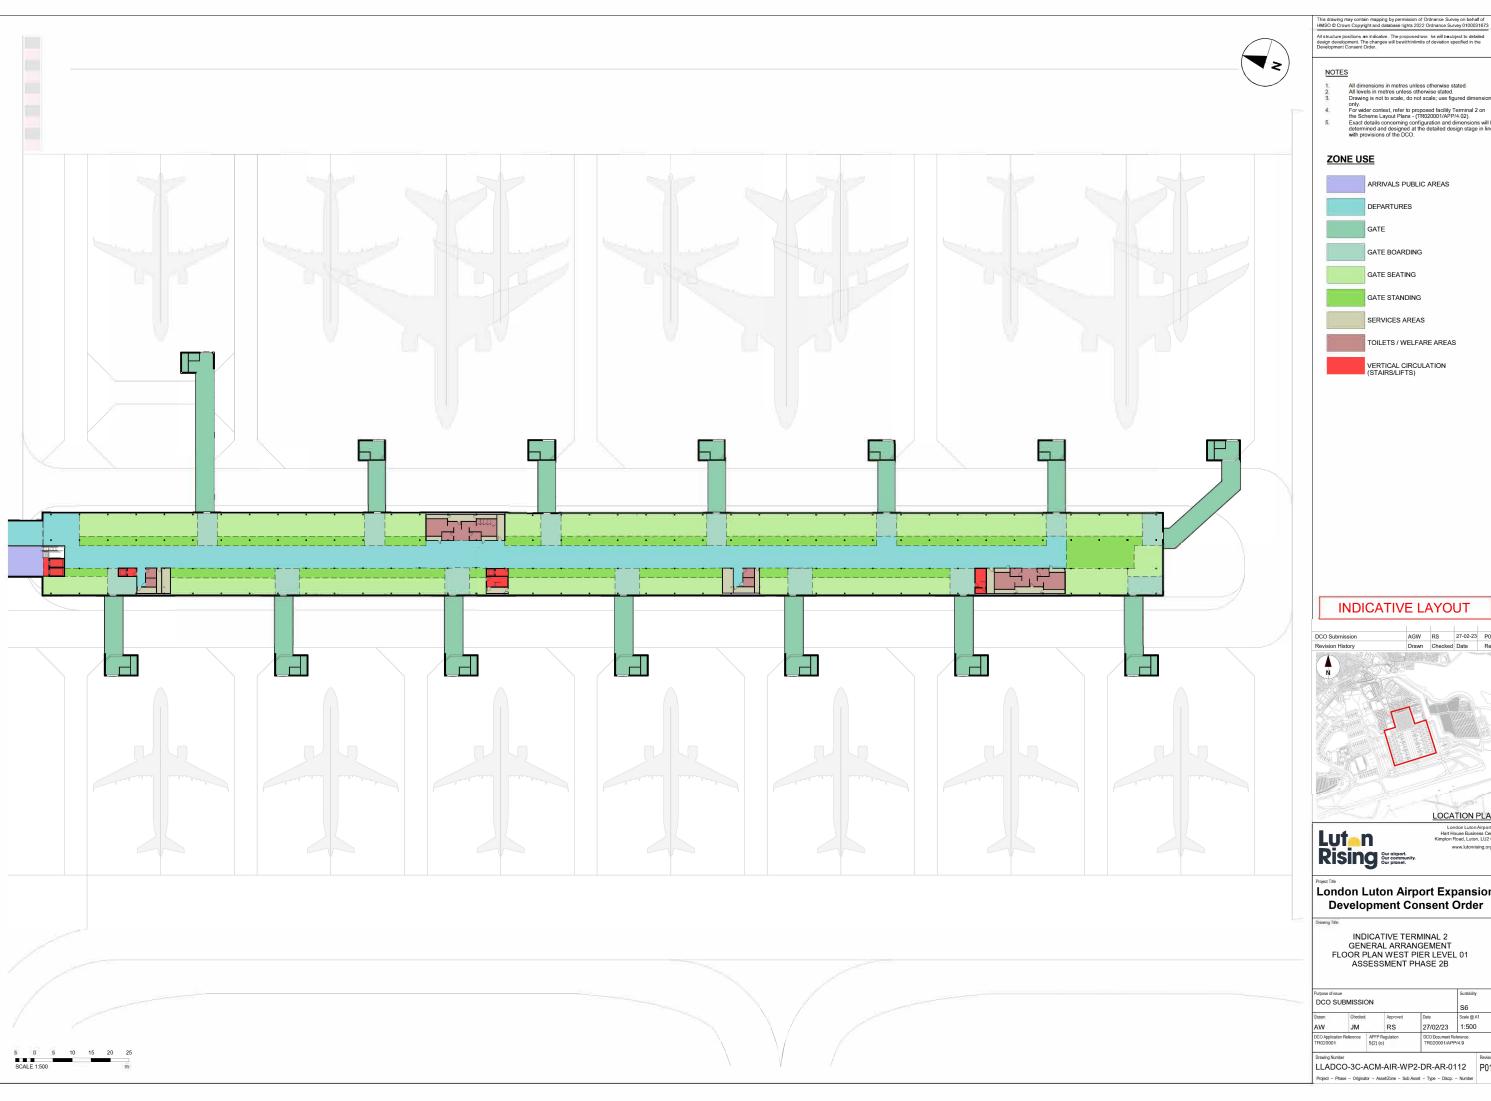

ARRIVALS PUBLIC AREAS DEPARTURES

GATE STANDING

TOILETS / WELFARE AREAS

INDICATIVE LAYOUT

AGW RS 27-02-23 P01
Drawn Checked Date Rev.

LOCATION PLAN


London Luton Airport Expansion **Development Consent Order**


INDICATIVE TERMINAL 2 GENERAL ARRANGEMENT FLOOR PLAN WEST PIER LEVEL 01 ASSESSMENT PHASE 2B

Purpose of iss	Suitability				
DCO S	S6				
Drawn Checked		Approved	Date	Scale @ A1	
AW	JM	RS	27/02/23	1:500	
		APFP Regulation 5(2) (o)	DCO Document R TR020001/API		

Drawing Number
LLADCO-3C-ACM-AIR-WP2-DR-AR-0112
P01



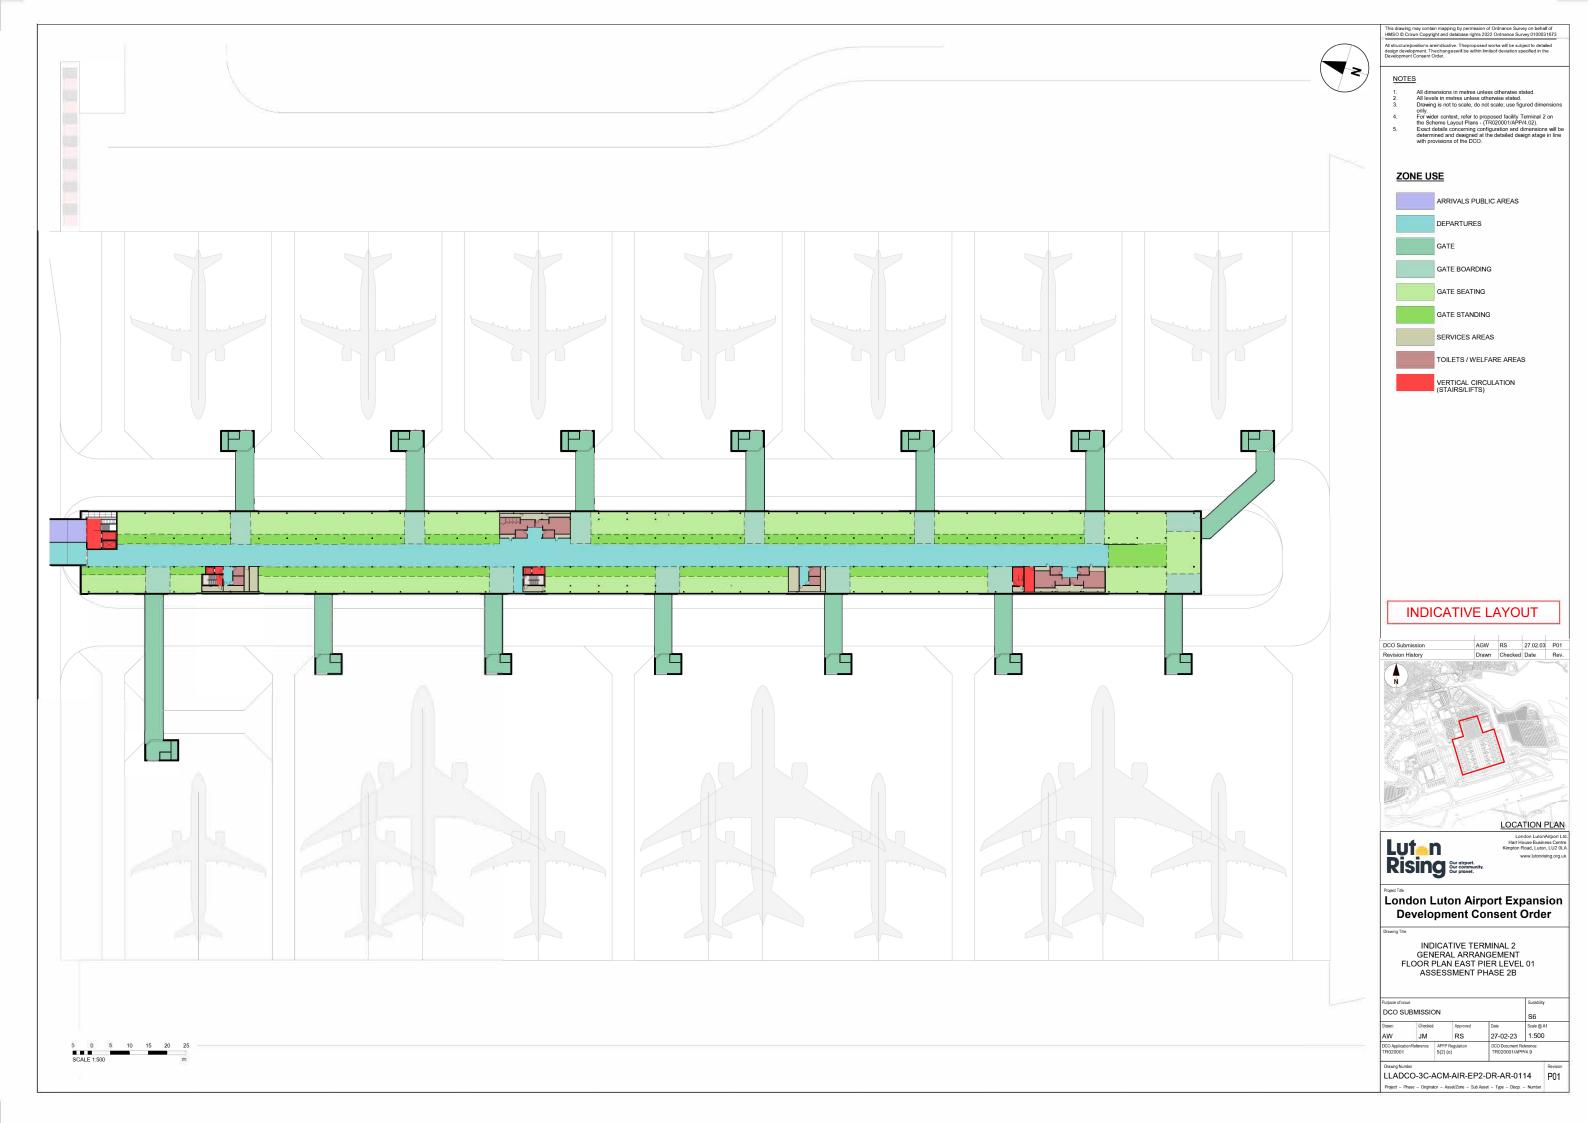

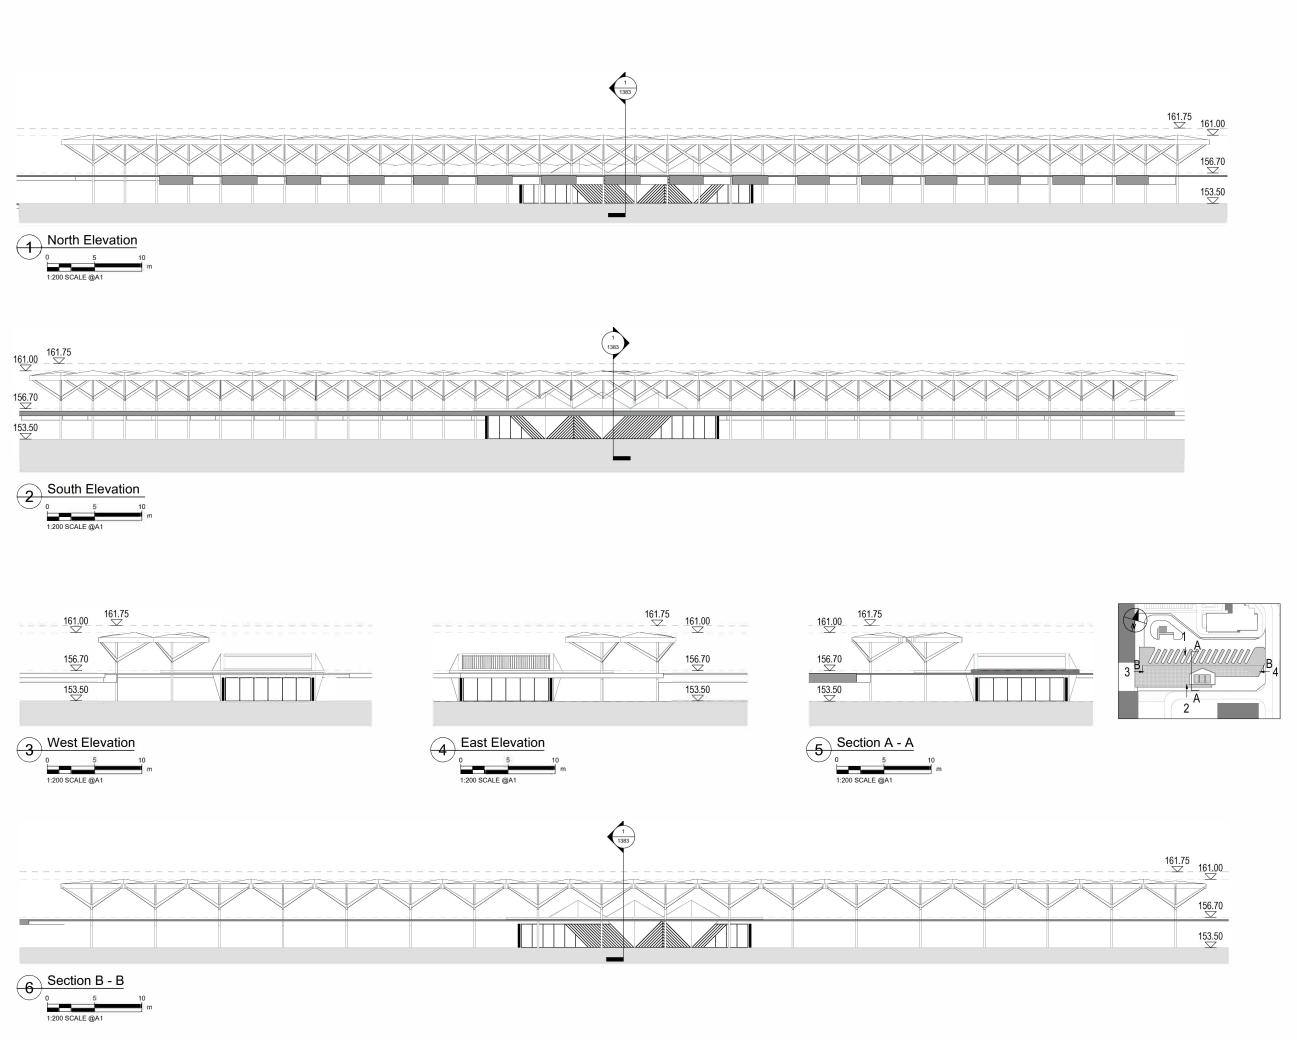

This drawing may contain mapping by permission of Ordnance Survey on behalf of HMSO © Crown Copyright and database rights 2022 Ordnance Survey 0100031673.

All structure positions are indicative. The proposed works will be subject to detailed designdevelopment. The changes will be withinlimits of deviation specified in the Development Croppert Ordnance.

NOTES

- This drawing is an indicative layout and can only be used for information purposes.
- for information purposes.

 2. Exact details concerning configuration and dimensions will be determined and designed at the detailed design stage in line with provisions of the DCO.
- Parameter heights are shown in metres above ordinand datum (AOD).
- For wider context, refer to proposed facility no.8 on the Scheme Layout Plans (TR020001/APP/4.02).

KE

177.00 Parameter height (AOD)

Maximum Parameter height lines

INDICATIVE LAYOUT

DCO Submisson	LC	GRM GU	27-02-23	P01
Revision History	Drawn	Checked Approved	Date	Rev.
	设施等国 (10 10 2	1	\perp
			NY	_ `
				1 13
		-200		Z-
		Carlo Ca		
	YAS A			`
1				
			7/10	10
		10		1
		10		
71111		52	SF.	1/
)			Y
				17
The state of the s		\	J	/
	1			1=
1 Table		LOCA	TION PI	AN
		LUCA	HONF	-AIN




Luton Rising Hart House Business Centre Kimpton Road, Luton, LU2 DLA www.lutonrising.org.uk


London Luton Airport Development Consent Order

Drawing Tr

INDICATIVE COACH STATION SECTIONS & ELEVATIONS

Purpose of issue	urpose of issue				
	S6				
Drawn LC	Checked GRM	Approved GU	27-02-23	1:200	Sz.
DCO Application TR020001	Ref APFI	P Regulation 5(2)(0)	TR020001/		
	C-CAP-ST	R-PRK-DR-	AR-1383	- flumber	P01

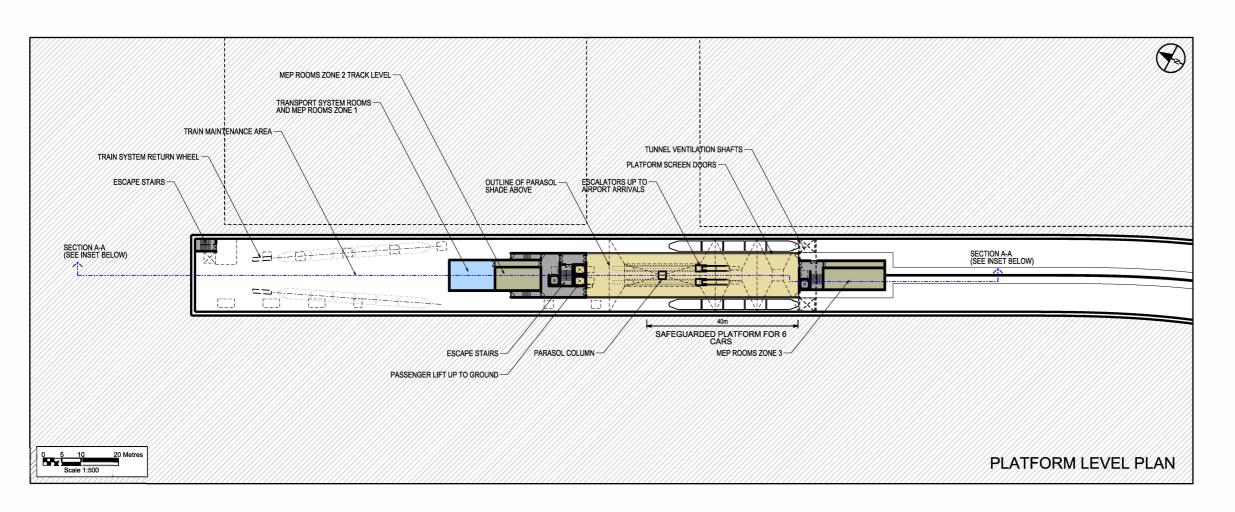

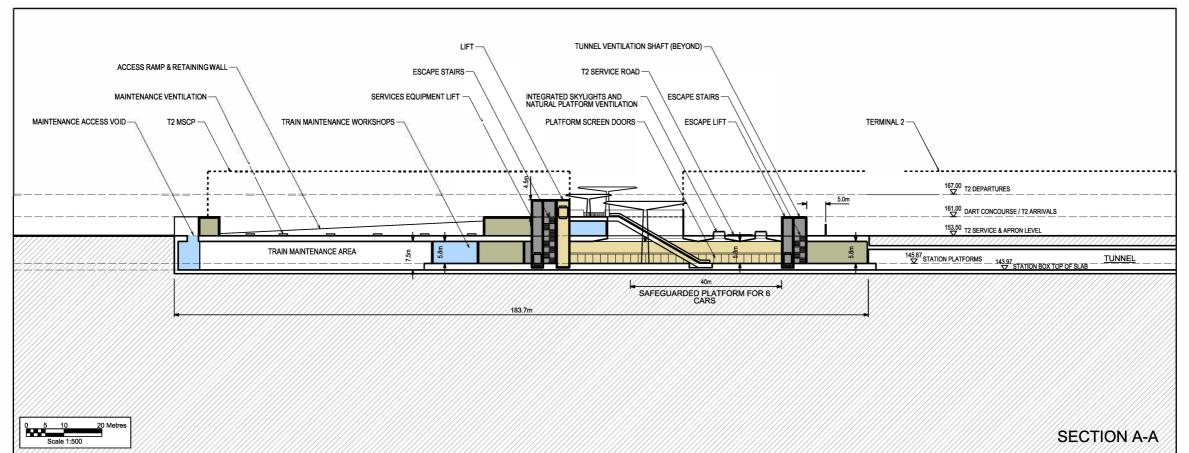

This drawing may contain mapping by permission of Ordnance Survey on behalf of HMSO @ Crown Copyright and database rights 2022 Ordnance Survey 0100031673 and structure positions are indicative. The proposed works will be subject to detailed design development. The changes will be within limits of deviation specified in the Development Consent Order.

NOTES

All dimensions shown in metres unless otherwise stated.

- Parameter heights are shown in metres Above Ordnance Datum (AOD).
- Exact details concerning configuration and dimensions will be determined and designed at the detailed design stage in line with provisions of the DCO.
- For wider context, refer to proposed facility 4 on the Scheme Layout Plans [TR020001/APP/4.02].

KEY

Maintenance Areas

Mechanical, Electrical and Plumbing (MEP) Areas

Escape Infrastructure

Passenger Areas

Existing Ground


--- Terminal 2 / MSCP Outline

Parameter Height (AOD)

— — Parameter Height Lines

INDICATIVE LAYOUT

DCO Submission	NS	CG CG	27/02/23	P0
Revision History	Drawn	Checked	Date	Rev
,		Approved		

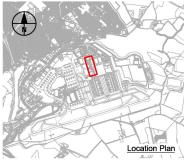



Kimpton Road, Luton, LU2 0LA

www.lutonrising.org.uk

London Luton Airport Expansion Development Consent Order

Drawing Tit

INDICATIVE LUTON DART EXTENSION- PLAN AND SECTION

Purpose of issue DCO SUBMISSION					Suitability	Suitability	
					S6		
Drawn	Checke	ed	Approved C.Gainey	Date 27/02/23	Scale 1:500	Size A1	
N.Scott	C.G	ainey					
DCO Application Ref. AP		APFP I	Regulation	DCO Document Ref.			
TR020001		5(2)(o)		TR020001/APP/4.09			
						-	


LLADCO-3C-ARP-RAL-MPT-DR-AR-6002
Project - Phase - Originator - Asset/Zone - Sub Asset - Type - Discp. - Number





Terminal 2 Service Yard Welfare Unit - East Elevation

1200 SCALE @A1

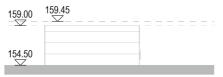


Terminal 2 Service Yard Welfare Unit - West Elevation

5 1200 SCALE @A1



Terminal 2 Service Yard Welfare Unit - North Elevation

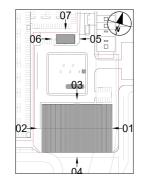

This drawing may contain mapping by permission of Ordnance Survey on behalf of HMSO © Crown Copyright and database rights 2022 Ordnance Survey 0100031673 All structure positions are inclinative. The proposed works will be subject to detailed design development. The changes will be within limits of deviation specified in the Development Crosself Criter.

NOTES

- This drawing is an indicative layout and can only be used for information purposes.
- Exact details concerning configuration and dimensions will be determined and designed at the detailed design stage in line with provisions of the DCO.
- Parameter heights are shown in metres above ordinan datum (AOD).
- For wider context, refer to proposed facility no.6 on the Scheme Layout Plans (TR020001/APP/4.02).

KEY

177.00 Parameter height (AOD)

— — Parameter height lines

— — Maximum Parameter height lines

INDICATIVE LAYOUT






Kimpton Road, Luton, LU2 0L www.lutonrising.org.i

London Luton Airport Development Consent Order

Drawing Title

INDICATIVE
ENERGY CENTRE
& TERMINAL 2 SERVICE YARD WELFARE UNIT
SECTIONS & ELEVATIONS

Purpose of issue						ity	
DCO SUBMISSION							
Drawn	Checked		Approved	Date	Scale	Size	
LC	GRM		GU	27-02-23	1:200) A1	
DCO Application Ref.		APFP Regulation		DCO Document Ref.			
TR020001		5(2)(o)		TR020001/APP/4.9			
Drawing Number						Revision	
LLADCO-3C-CAP-STR-WRH-DR-AR-1312						P01	

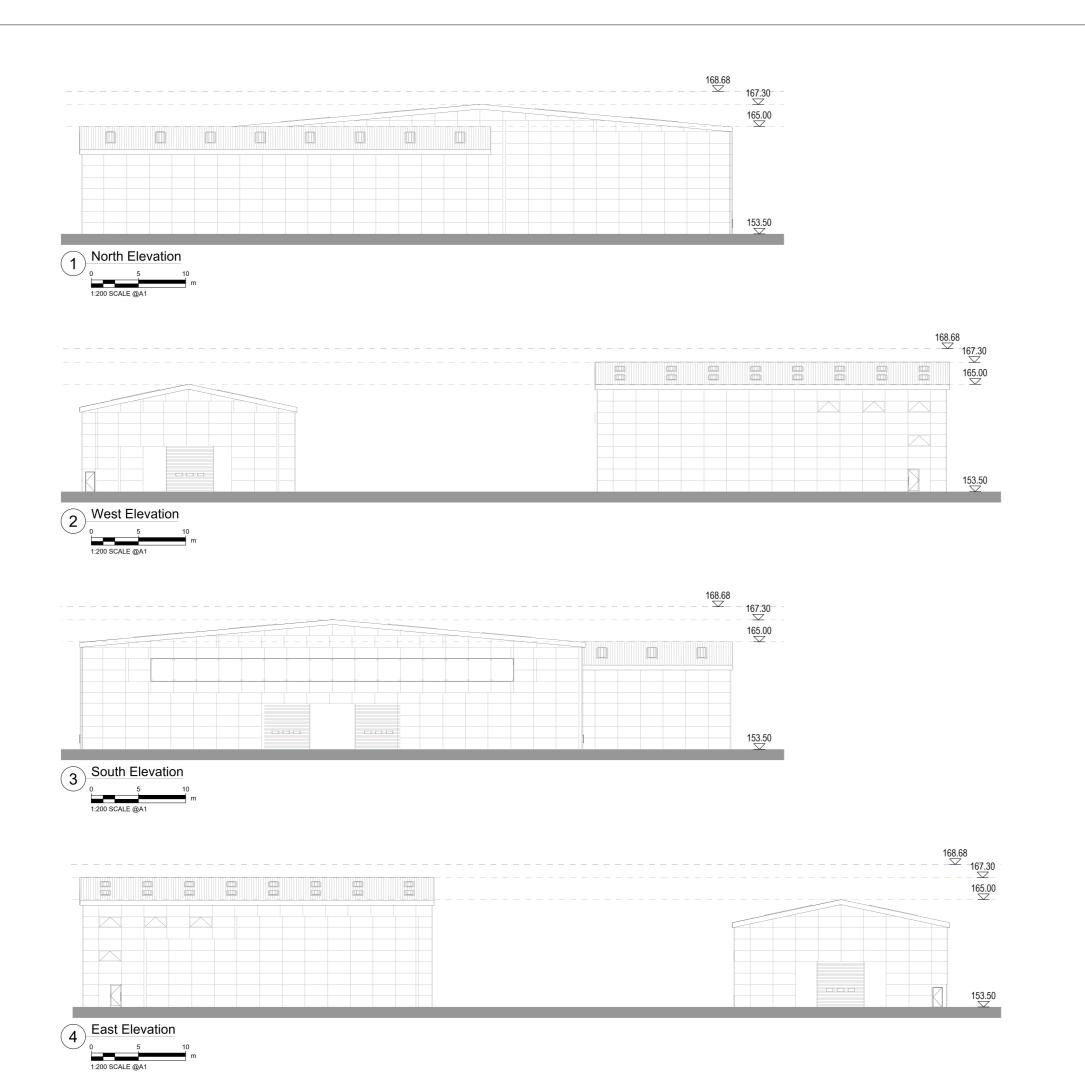

This drawing may contain mapping by permission of Ordmance Survey on behalf of HMSO © Crown Copyright and database rights 2022 Ordmance Survey 0100031673 All structure positions are indicative. The proposed works will be subject to detailed design development. The changes will be within limits of deviation specified in the Development Consent Order.

NOTES

- . This drawing is an indicative layout and can only be used for information purposes.
- Exact details concerning configuration and dimensions will be determined and designed at the detailed design stage in line with provisions of the DCO.
- Parameter heights are shown in metres above ordinan datum (AOD).
- For wider context, refer to proposed facility no.7 on the Scheme Layout Plans (TR020001/APP/4.02).

KEY


177.00

Parameter height (AOD)

— — Parameter height lines

Maximum Parameter height lines

INDICATIVE LAYOUT

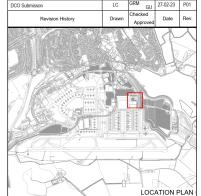



Hart House Business Centre Kimpton Road, Luton, LU2 0LA www.lutonrising.org.uk

London Luton Airport Development Consent Order

Drawing

INDICATIVE AIRPORT OPERATIONS AND MAINTENANCE ELEVATIONS

Purpose of issue					Suitability	
	S6					
Drawn	Checked		Approved	Date	Scale	Size
LC	GRM		GU	27-02-23	1:200	A1
DCO Application Ref. A		APFP F	Regulation	DCO Document Ref.		
TR020001		5(2)(o)		TR020001/APP/4.9		

Drawing Number
LLADCO-3C-CAP-STR-WRH-DR-AR-1354